## 1130 & 1132 MISSION



#### **PROJECT DIRECTORY**

**CLIENT/TENANT** 

CONTACT: DOUG R. WALLACE 1130 MISSION ST. SANTA CRUZ, CA 95060 P: 831-254-1029 E: doug3g@gmail.com

**ARCHITECT** 

WORKBENCH CONTACT: JAMILEH CANNON 189 WALNUT AVE. SANTA CRUZ, CA 95060

P: 831.227.2217 E: jamileh@workbenchbuilt.com

**CONTRACTOR** WORKBENCH

**CONTACT: TIM GORDIN** 189 WALNUT AVE. SANTA CRUZ, CA 95060 P: 831.227.2217

E: tim@workbenchbuilt.com

**CIVIL ENGINEER** 

IFLAND ENGINEERS 5300 SOQUEL AVE., **SUITE 101** SANTA CRUZ, CA 95062

P: 831.426.5313

E: info@iflandengineers.com

LANDSCAPE ARCHITECT

MBLA, LANSCAPE ARCHITECTURE MEGAN BISHOP PO BOX 328 APTOS, CA 95001 P: 831.818.9227 E: megan@mb-landarch.com

**GEOTECHNICAL ENGINEER** 

ROCK SOLID ENGINEERING, INC. YVETTE WILSON 1100 MAIN STREET, SUITE A, WATSONVILLE, CALIFORNIA 95076, UNITED STAT P: 831.724.5868 E:office@rocksolidengineers.com

#### **CODE INFORMATION A**

- 2022 CALIFORNIA BUILDING CODE
- 2022 CALIFORNIA RESIDENTIAL CODE 2022 CALIFORNIA ELECTRICAL CODE
- 2022 CALIFORNIA PLUMBING CODE
- 2022 CALIFORNIA MECHANICAL CODE
- 2022 CALIFORNIA FIRE CODE
- 2022 CALIFORNIA GREEN BUILDING STANDARDS 2022 CALIFORNIA ENERGY EFFICIENCY

SANTA CRUZ COUNTY CODE AMENDMENTS


- REQUIRED BY SCMC 6.100, DESIGNED IN ACCORDANCE WITH CHAPTER
- NATURAL GAS-FREE DESIGN AS 6.100 OF THE MUNICIPAL CODE.

006-203-24 & 006-203-25 03/11/2024

PLANNING PACKAGE

DRAWING INDEX - PLANNING PACKAGE COVER SHEET INDEX PROJECT INFO **EXISTING SITE PHOTOS** GP0.04 **OPEN SPACE EXHIBIT** GP0.05 **BONUS DENSITY EXHIBIT** GP0.07 RENDERINGS AND 3D EXHIBITS SHADOW STUDY 5\ GP0.09 **GROSS AREA PLAN EXHIBITS NET UNIT AREA PLAN EXHIBITS** LAND SURVEY LAND SURVEY (FOR REFERENCE ONLY) CIVIL C1.0 PRELIMINARY DEMOLITION PLAN C2.0 PRELIMINARY GRADING & DRAINAGE PLAN C3.0 PRELIMINARY UTILITY PLAN PRELIMINARY STORMWATER CONTROL PLAN C4.1 PRELIMINARY STORMWATER CONTROL DETAILS C5.0 PRELIMINARY LOT LINE ADJUSTMENT MAP ARCHITECTURAL AP0.50D PROPOSED DEMO SITE PLAN AP0.51 PROPOSED SITE PLAN AP1.01 PROPOSED FLOOR PLAN - LEVEL 1 PROPOSED FLOOR PLAN - LEVEL 2 PROPOSED FLOOR PLAN - LEVEL 3 AP1.04 PROPOSED FLOOR PLAN - LEVEL 4 AP1.05 PROPOSED FLOOR PLAN - LEVEL 5 AP1.06 PROPOSED ROOF PLAN AP3.01 PROPOSED ELEVATIONS AP3.02 PROPOSED ELEVATIONS AP3.03 PROPOSED ELEVATIONS AP4.01 **BUILDING SECTIONS** AP4.02 **BUILDING SECTIONS** AP5.01 **ENLARGED WALL SECTIONS** AP9.01 CAR, EV, BICYCLE PARKING, & STORAGE INFO LANDSCAPE L1.1 LANDSCAPE PLAN GROUND LEVEL L1.2 LANDSCAPE PLAN LEVEL 2 L1.3 LANDSCAPE PLAN LEVEL 5 L1.4 LANDSCAPE PLAN ROOF LEVEL

#### **GRAPHIC LEGEND**

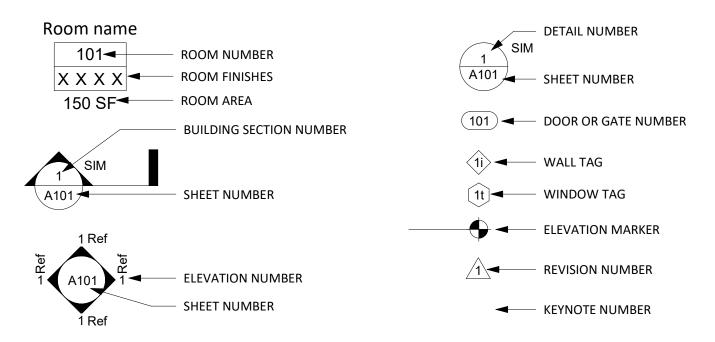



189 WALNUT AVENUE SANTA CRUZ, CA 95060 WORKBENCHBUILT.COM P: 831.227.2217

MISSION

 $\vdash$ 



1130 SANT

Issue	DESCRIPTION	D.
	SB330 PRE-APPLICATIO	V 01.09
0	PLANNING APPLICATION	V 06.0
1	PLANNING REV-01	08.2
2	PLANNING REV-02	01.0
3	PLANNING REV-03	03.1
4	PLANNING REV-04	04.1
5	PLANNING REV-05	04.2
A DA	l Number	006-203
7		
Pro	ject number	21
Prir	it Date	01.09.2
Dra	wn by	
Che	cked by	
Sca	le	

**COVER SHEET INDEX** 

1132 MISSION ST

1130 MISSION ST

006-203-24

006-203-25

SANTA CRUZ, CA 95060

5,314.3 SF (0.122 ACRES)

SANTA CRUZ, CA 95060

7,187.4 SF (0.165 ACRES)

12,501.7 SF (0.287 ACRES)

√<sub>3</sub> TYPE III-A: 34,890 SF

R-2 (RESIDENTIAL)

B (COMMERCIAL)

S-2 (GARAGE)

1,505 SF 738 SF

TYPE III-A: 4-STORIES

2,243 SF/12,501 SF = 17.9%

9,852 SF/12,501 SF = 78.8%

1 SPACE (2% OF 24 SPACES)

2 VAN ACCESSIBLE SPACES

2 VAN ACCESSIBLE PARKING SPACES W/ EV CHARGING STATIONS

1 SPACE (FOR 1-25 REQUIRED SPACES)

2 SPACES (1 PER 6 COMMERCIAL SPACES, 1 PER 8 RESIDENTIAL)

COMMERCIAL:

TOTAL PARKING PROVIDED:

10 STANDARD SIZE EV PARKING SPACES

VAN SPACES:

TOTAL:

CC - COMMUNITY COMMERCIAL

MXMD - MIXED MEDIUM DENSITY

**PROJECT DATA** 

**LOT 1 ADDRESS:** 

**LOT 2 ADDRESS:** 

**TOTAL LOT SIZE:** 

**ZONING DISTRICT:** 

**GENERAL PLAN DESIGNATION:** 

**BUILDING OCCUPANCIES:** 

**EXISTING BUILDING 1 AREA:** 

**EXISTING BUILDING 2 AREA:** 

(TO BE DEMOLISHED)

CBC 1109A.3

CBC 11B 208.2

CBC 1109A.8.6

CBC 11B-208.2.4 &

**EXISTING LOT COVERAGE:** 

**PROPOSED LOT COVERAGE:** 

FLOOR AREA RATIO (FAR) ALLOWED:

FLOOR AREA RATIO (FAR) PROPOSED:

(WAIVER #3 SOUGHT PER STATE DENSITY BONUS)

**TOTAL EXISTING BUILDING AREA:** 2,243 SF

**BUILDING CONSTRUCTION TYPE:** TYPE I-A: 9,853 SF

**PROPOSED NUMBER OF STORIES:** TYPE I-A: 1-STORY

APN:

APN:

LOT SIZE:

**LOT SIZE:** 

RESIDENTIAL RESIDENTIAL 33,406 GSF 9,853 GSF **TOTAL** 43,259 GSF

**PROJECT UNIT COUNT** 

			_ NOTE:
7	UNIT TYPE	COUNT	REFER TO SHEET GP0.05 FOR DENSITY
	UNIT A	30	BONUS EXHIBIT AND CALCULATIONS
┨	UNIT B	18	]
		48	REFER TO SHEET GP0.10 FOR NET
J	•		UNIT AREA EXHIBIT

INUNDATION BY 100-YEAR FLOOD:

RECORDED PUBLIC EASEMENTS:

SPECIES OF CONCERN:

COASTAL ZONE:

DELINEATED EARTHQUAKE FAULT ZONE:

NO, PER CITY G.I.S. AND FEMA FLOOD HAZARD AREA MAPS

NO, NO KNOWN SPECIES OF CONCERN ON SITE PER BIOTIC

YES, SEE SITE SURVEY INCLUDED FOR ALL APPLICABLE

NO, PER USGS EARTHQUAKE FAULT ZONE MAP

REPORT (SEE ATTACHED)

PUBLIC EASMENTS.

NO, PER CITY G.I.S.

#### **SCOPE OF WORK**

THE PROJECT WILL BE APPROXIMATELY 43,259 GROSS SQUARE FEET WITH 4 STORIES OF TYPE III-A OVER ONE STORY OF TYPE I-A NEW CONSTRUCTION. 47 UNITS OF SINGLE ROOM OCCUPANCY (SRO) HOUSING ARE PROPOSED ABOVE A 2,627 SF COMMERCIAL SPACE ON THE GROUND FLOOR. THE BUILDING IS 5 STORIES TALL IN TOTAL AND UTILIZES THE STATE DENSITY BONUS AS WELL AS SB-330 AND CA AB 2097. WAIVERS ARE REQUESTED FOR:

- **BUILDING HEIGHT**
- SETBACKS
- 3. FLOOR AREA RATIO (FAR)

#### CONCESSIONS ARE REQUESTED FOR:

IMPACT FEES TO BE PAID AT FINAL CERTIFICATE OF OCCUPANCY

REMOVE REQUIREMENTS FOR CONSTRUCTION OF BUILDING FEATURES FOR POTENTIAL FUTURE USES NOT PROPOSED IN THE APPLICATION

THIS PROPOSAL SEEKS TO DEMOLISH THE EXISTING BUILDINGS AND BUILD NEW CONSTRUCTION. THE (2) EXISTING BUILDINGS CURRENTLY UNDERUTILIZE THE (2) SUBJECT PARCELS AND ARE NOTED AS HAVING A "LOW CONTRIBUTION TO URBAN QUALITY IN THE SANTA CRUZ MISSION STREET URBAN DESIGN PLAN". THERE ARE (2) SMALL EXISTING SINGLE STORY COMMERCIAL BUILDINGS OCCUPIED BY A SINGLE GROCER TENANT THE EXISTING BUILDINGS TEND TO FLOOD, REQUIRE NEW ROOFS AND OTHER REPAIRS, AND IT IS EXPECTED THAT ONGOING MAINTENANCE OF THE BUILDINGS WILL BE COSTLY AND DISRUPTIVE TO THE SERVICE PROVIDED TO THE COMMUNITY.

THE PROPOSED NEW CONSTRUCTION PROVIDES PEDESTRIAN FRIENDLY COMMERCIAL SPACE ON THE GROUND FLOOR AS WELL AS AN APPROX. 5,722 SF PARKING GARAGE WITH ELECTRIC VEHICLE CHARGING STATIONS AND ACCESSIBLE PARKING.

THERE IS A LOBBY ENTRY SPACE FOR RESIDENTS WITH AMENITIES INCLUDING A MAIL/PACKAGE ROOM AND RENTAL OFFICE, AND THERE IS A LARGE OPEN AIR COURTYARD FOR RESIDENTIAL USE ON THE 2ND FLOOR ABOVE THE GROUND FLOOR PODIUM. OTHER AMENITIES LOCATED THROUGHOUT THE PROPOSED BUILDING INCLUDE ADDITIONAL BICYCLE PARKING ROOMS ON EACH STORY WITH LONG-TERM BICYCLE PARKING FOR EVERY UNIT (CLASS-I), AND RESIDENT STORAGE PER SANTA CRUZ SRO CODE REQUIREMENTS. AMENITIES PROVIDED FOR RESIDENTIAL TENANTS ON FLOORS 2-5 INCLUDE COMMON USE AREAS, LAUNDRY AREAS AND TRASH/RECYCLING/COMPOST FACILITIES.

LEVELS 2 THROUGH 5 HOST SRO UNITS ON EACH FLOOR WITH INDIVIDUAL KITCHENS AND FULL BATHROOMS. LEVEL 5 HOSTS SHARED BALCONY AMENITY SPACE.

AN APPROX. 2,627 SF COMMERCIAL SPACE IS PLANNED ALONG THE FRONTAGE OF MISSION STREET WITH AN ASSOCIATED COVERED OUTDOOR ENTRY AT THE CORNER OF MISSION AND LAUREL STREETS. SUPPORTING UTILITY SPACES FOR BOTH THE COMMERCIAL AND THE RESIDENTIAL SPACES ARE PROVIDED. PUBLIC BICYCLE PARKING (CLASS-II) IS INCLUDED ALONG LAUREL STREET.

THE BUILDING'S MASSING ORIENTS THE RESIDENT COURTYARD TOWARDS LAUREL CREEK, PROVIDING GREEN VIEWS FOR RESIDENTS AND ACCOMMODATING REQUIRED CREEK DEVELOPMENT SETBACKS. SOME ROOF SPACE IS INTENDED FOR MECHANICAL EQUIPMENT AND SOLAR PHOTOVOLTAICS. SOME GREEN ROOF SPACE WILL BE PROVIDED AS WELL.

1.1.0				
PLANNING CODE NOTES  BUILDING HEIGHT (WAIVER #1 SOUGHT PER STATE DENSITY BONUS)  & STORIES ALLOWABLE: 40' PROPOSED:	<b>66'</b>	BICYCLE PARKING 24.12.1030 (7) 24.12.250(2)(b) 24.12.250(2)(b)	REQUIRED: RESIDENTIAL:	48 SPACES (1 SPACE / UNIT) 48 CLASS-I SPACES (1 SPACE / UNIT) = 12 CLASS-II SPACES (1 SPACE / 4 UNITS)
SCMC 24.10.750 ALLOWABLE: 3-STORIES PROPOSED:  ALLOWABLE STAIRS - 12'	5-STORIES NO RESTRICTION	24.12.250(2)(a) 24.12.250(2)(a)	COMMERCIAL:	1 CLASS-I SPACE (20% OF 2 + 15% OF CAR SPACES) = 20% (2 + (15% OF 14)) = 20% (2.1 = 3) = 0.6 = 1
PROPOSED: SEE ELEVATIONS  SETBACKS REQUIRED (WAIVER #2 SOUGHT PER STATE DENSITY BONUS)				3 CLASS-II SPACES (80% OF 2 + 15% OF CAR SPACES) =80% (2 + (15% OF 14)) = 80% (2.1 = 3) = 2.4 = 3
SCMC 24.10.750 FRONT YARD: 0' CREEK MANAGEMENT A  REAR YARD: 0' CREEK DEVELOPMENT SI	<b>ETBACK</b> : 15'		TOTAL:	60 CLASS-I SPACES 18 CLASS-II SPACES
SIDE YARDS: 0' CREEK RIPARIAN SETBAC ADJACENT RESIDENTIAL YARD, ADJACENT TO R15 ZON		SEE PLANS	PROVIDED:	82 CLASS-I SPACES 32 CLASS-II SPACES
	•	<u>RESIDENT STORAGE</u> 24.12.1030 (6)	REQUIRED: RESIDENTIAL: PROVIDED: RESIDENTIAL:	48 STORAGE SPACES (1 SPACE / UNIT) 48 RESIDENTIAL STORAGE LOCKERS (SEE PLANS) 1
$\wedge$	PER 250 SF OF FLOOR AREA)  KING REQUIREMENT ON ANY PROJECT, AS DEFINED, THAT IS	PERMITTED USE MISSION STREET URBAN DESIGN PLAN	STREET C-C DIST DEPENDENT ON ATTRACTIVE, PE AUTO-ORIENTED PROVIDED:	OOR RESIDENTIAL USE, MOST APPROPRIATE USE FOR MISSION RICTS INCLUDES GOODS/SERVICES, VISITOR-SERVING SERVICE HIGHWAY VISIBILITY/FRONTAGE, COMPATIBLE W/ AN DESTRIAN-FRIENDLY COMMERCIAL DISTRICT, NOT PRIMARILY D.  LIES (SEE SHEET AP2.01)
ELECTRICAL VEHICLE CHARGING PARKING SPACES AND PROHIBITED.  EV PARKING REQUIRED:  SCMC 21.12.241 RESIDENTIAL: 3 SPACES (12% OF 24 SPACES)  COMMERCIAL: 1 SPACE (FOR 10-25 REQUIRED SPACE)  TOTAL: 4 SPACES		USABLE OPEN SPACE SCMC 24.12.1030 (1)	200 SF COMMOI PROVIDED:	JNIT AND NO LESS THAN 200 SF COMMON OUTDOOR AND N INDOOR OPEN SPACE) LEET GP0.04 FOR OPEN SPACE EXHIBIT)
CGBSC 4.106.4.2 TOTAL: 4 SPACES (10% OF 38 SPACES)  ACCESSIBLE PARKING REQUIRED:		ADDITIONAL SITE COND		SPECIAL FLOOD HAZARD
		I DOINT COLIBCE VIB (WATER DOLL	LITANITS. NO NOME EX	VISTING AND NO PROPOSED POINT SOURCE INUNDATION BY 100-YEA

POINT SOURCE AIR/WATER POLLUTANTS:

**VERY HIGH FIRE SEVERITY ZONE:** 

SENSITIVE HABITAT (WETLANDS):

HAZARDOUS WASTE SITE:

HISTORIC ARCHAEOLOGY SENSITIVITY:

NO, NONE EXISTING AND NO PROPOSED POINT SOURCE

NO, PER CAL FIRE 2022 FIRE HAZARD SEVERITY ZONE MAP

NO, PER U.S. FISH AND WILDLIFE NATIONAL WETLANDS SURVEY


NO KNOWN HISTORIC AND/OR HISTORIC RESOURCES

NO, PER DTSC HAZARDOUS WASTE SITE LIST

AIR/WATER POLLUTANTS

#### **ZONING MAP ASSESSORS MAP** SUBJECT PROPERTIES! 49 R-11-5 19 Note - Assessor's Parcel & Block City of Santa Cruz Numbers are Shown in Circles. County of Santa Cruz, Calif. **SUBJECT PROPERTIES**

#### **CONTEXT & MOBILITY**

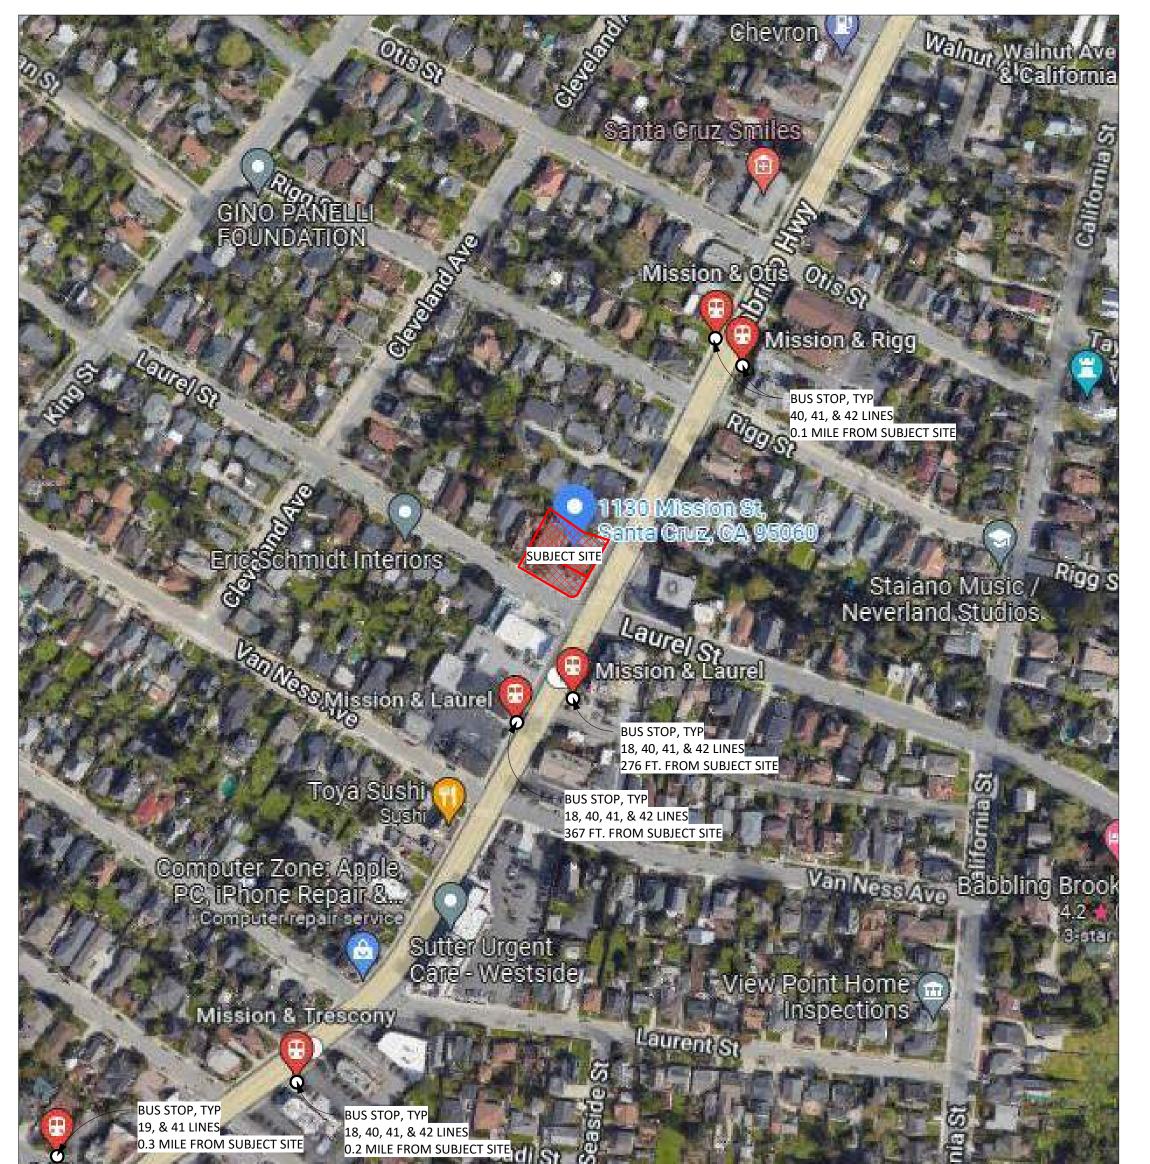

#### STREAM OR OTHER RESOURCE:

NO, PER CITY G.I.S. AND CALIFORNIA FISH AND GAME STREAM MAP.

ANY APPROVALS UNDER THE SUBDIVISION MAP ACT, INCLUDING, BUT NOT LIMITED TO, A PARCEL MAP, A TENTATIVE MAP, OR A

CONDOMINIUM MAP, BEING REQUESTED: NO, NONE ARE BEING REQUESTED.

PROJECT INFO

workbench

189 WALNUT AVENUE SANTA CRUZ, CA 95060 WORKBENCHBUILT.COM P: 831.227.2217

> **MISSIO** 7 3 Ø

10N ST 95060

7

MISION

30

Issue	DESCRIPTION		D.
	SB330 PRE-APPLICATION	N	01.0
0	PLANNING APPLICATION	N	06.0
1	PLANNING REV-01		08.2
2	PLANNING REV-02		01.0
3	PLANNING REV-03		03.1
5	PLANNING REV-05		04.2
APN	l number	006	5-203
Proj	ject number		21
Prin	t Date	01.	09.2
Dra	wn by		
Che	cked by		
Scal	e		



MISION ST. , CA 95060

P: 831.227.2217

# MISSION




































Issue	DESCRIPTION	DAT
	SB330 PRE-APPLICATIO	N 01.09.2
0	PLANNING APPLICATIO	N 06.01.2
1	PLANNING REV-01	08.25.2
2	PLANNING REV-02	01.04.2
3	PLANNING REV-03	03.11.2
APN	l number	006-203-2
Proj	ect number	211
Prin	t Date	01.09.20
Dra	wn by	
Che	cked by	[
Scal	e	N.

EXISTING SITE PHOTOS

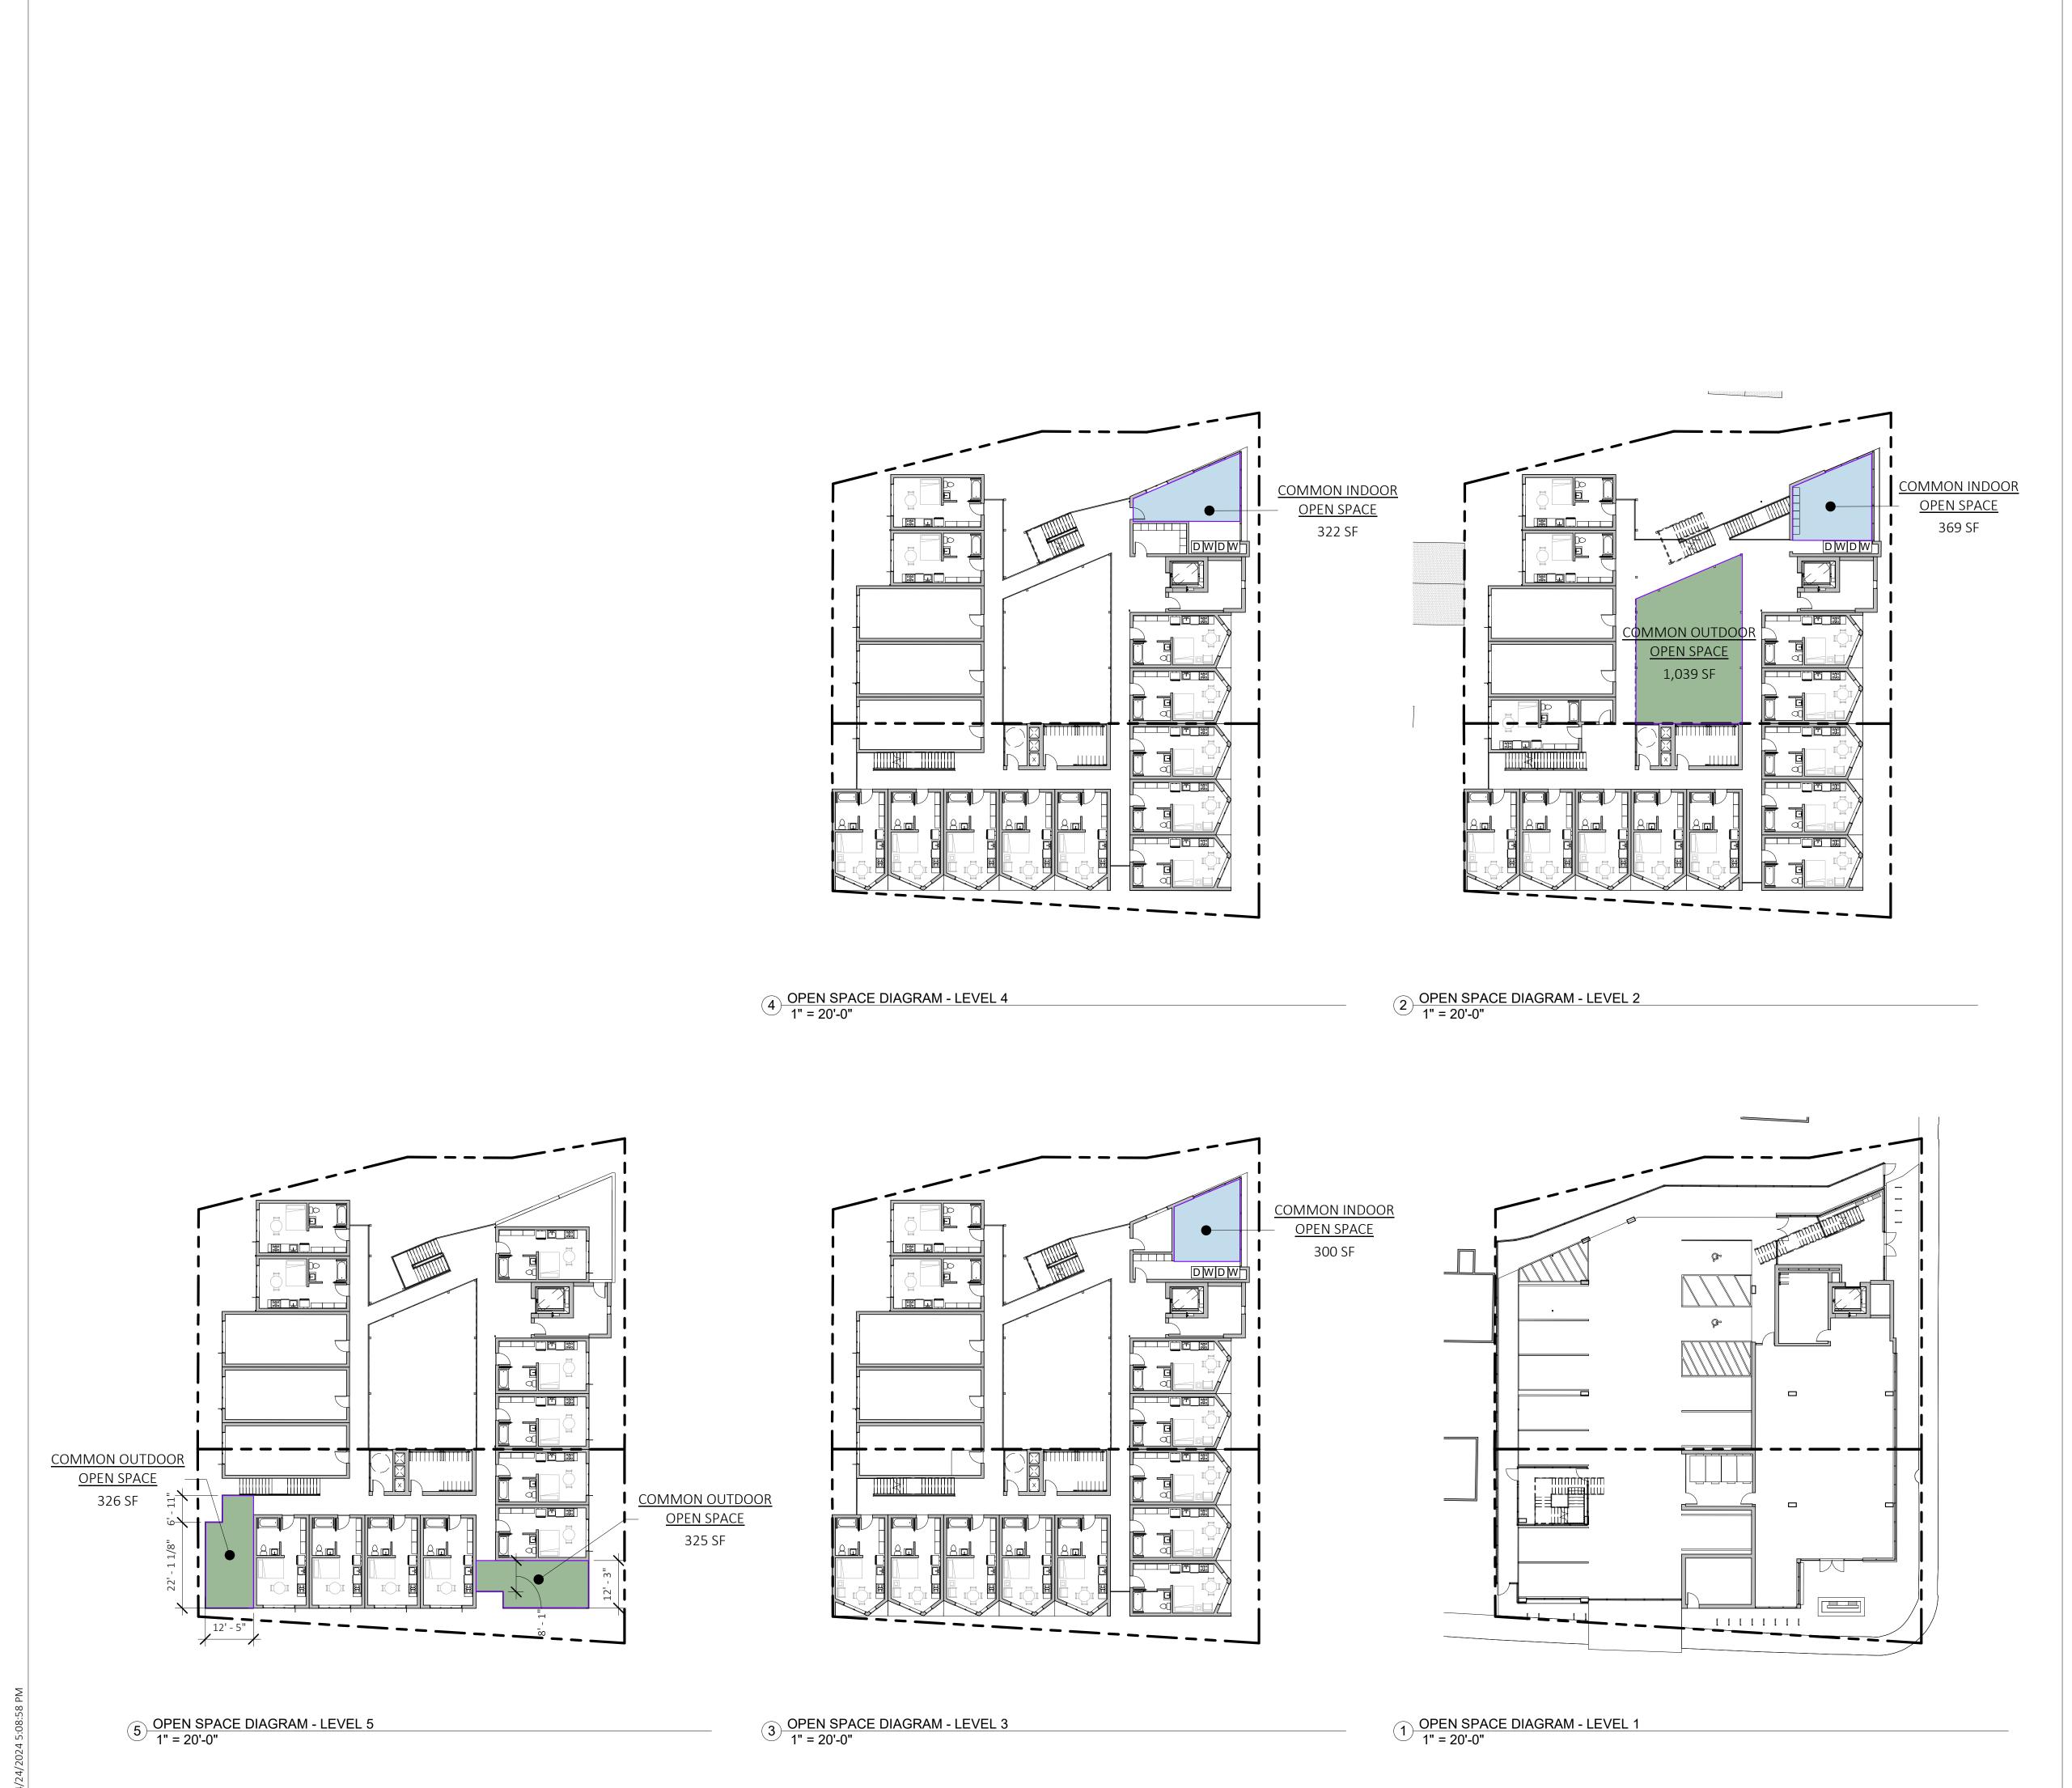

### CITY OF SANTA CRUZ SHARED OPEN SPACE REQUIREMENTS SCMC 21.12.1030 (1)

TOTAL UNIT COUNT: 48 UNITS

A MINIMUM OF 200 SF OF COMMON OUTDOOR OPEN SPACE
AND 200 SF OF COMMON INDOR SPACE IS REQUIRED

COMMON OUTDOOR OPEN SPACE PROVIDED: 1,691 SF

COMMON INDOOR OPEN SPACE PROVIDED: 992 SF

SHARED USABLE OPEN SPACE REQ'D: 480 GSF

#### **USABLE OPEN SPACE PROVIDED**

OSABLL O	OSABLE OF LIN SPACE PROVIDED								
LEVEL	COMMON OUTDOOR OPEN SPACE	COMMON INDOOR OPEN SPACE	TOTALS						
LEVEL 1	0 SF	0 SF	232 SF						
LEVEL 2	1,039 SF	369 SF	1,408 SF						
LEVEL 3	0 SF	300 SF	300 SF						
LEVEL 4	0 SF	322 SF	322 SF						
LEVEL 5	652 SF	0 SF	652 SF						
GRAND TOTALS	1,691 SF	992 SF	2,915 SF						

#### **OPEN SPACE LEGEND**

COMMON OUTDOOR OPEN SPACE

COMMON INDOOR OPEN SPACE



189 WALNUT AVENUE SANTA CRUZ, CA 95060 WORKBENCHBUILT.COM P: 831.227.2217

## 1130 & 1132 MISSION

MISION ST. , CA 95060

. 1132 CRUZ,

1130 SANT




Issue	DESCRIPTION	ON	DATE
	SB330 PRE-APPL	ICATION	01.09.202
0	PLANNING APPLI	CATION	06.01.202
1	PLANNING RE	V-01	08.25.202
2	PLANNING RE	V-02	01.04.202
3	PLANNING RE	V-03	03.11.202
APN	l number	006	5-203-25
Proj	ject number		21128
Prin	t Date	01	.09.2023
Dra	wn by		DS
Che	cked by		EB
Scal	e	As ir	ndicated

OPEN SPACE EXHIBIT

GP0.04

TRUE PROJECT

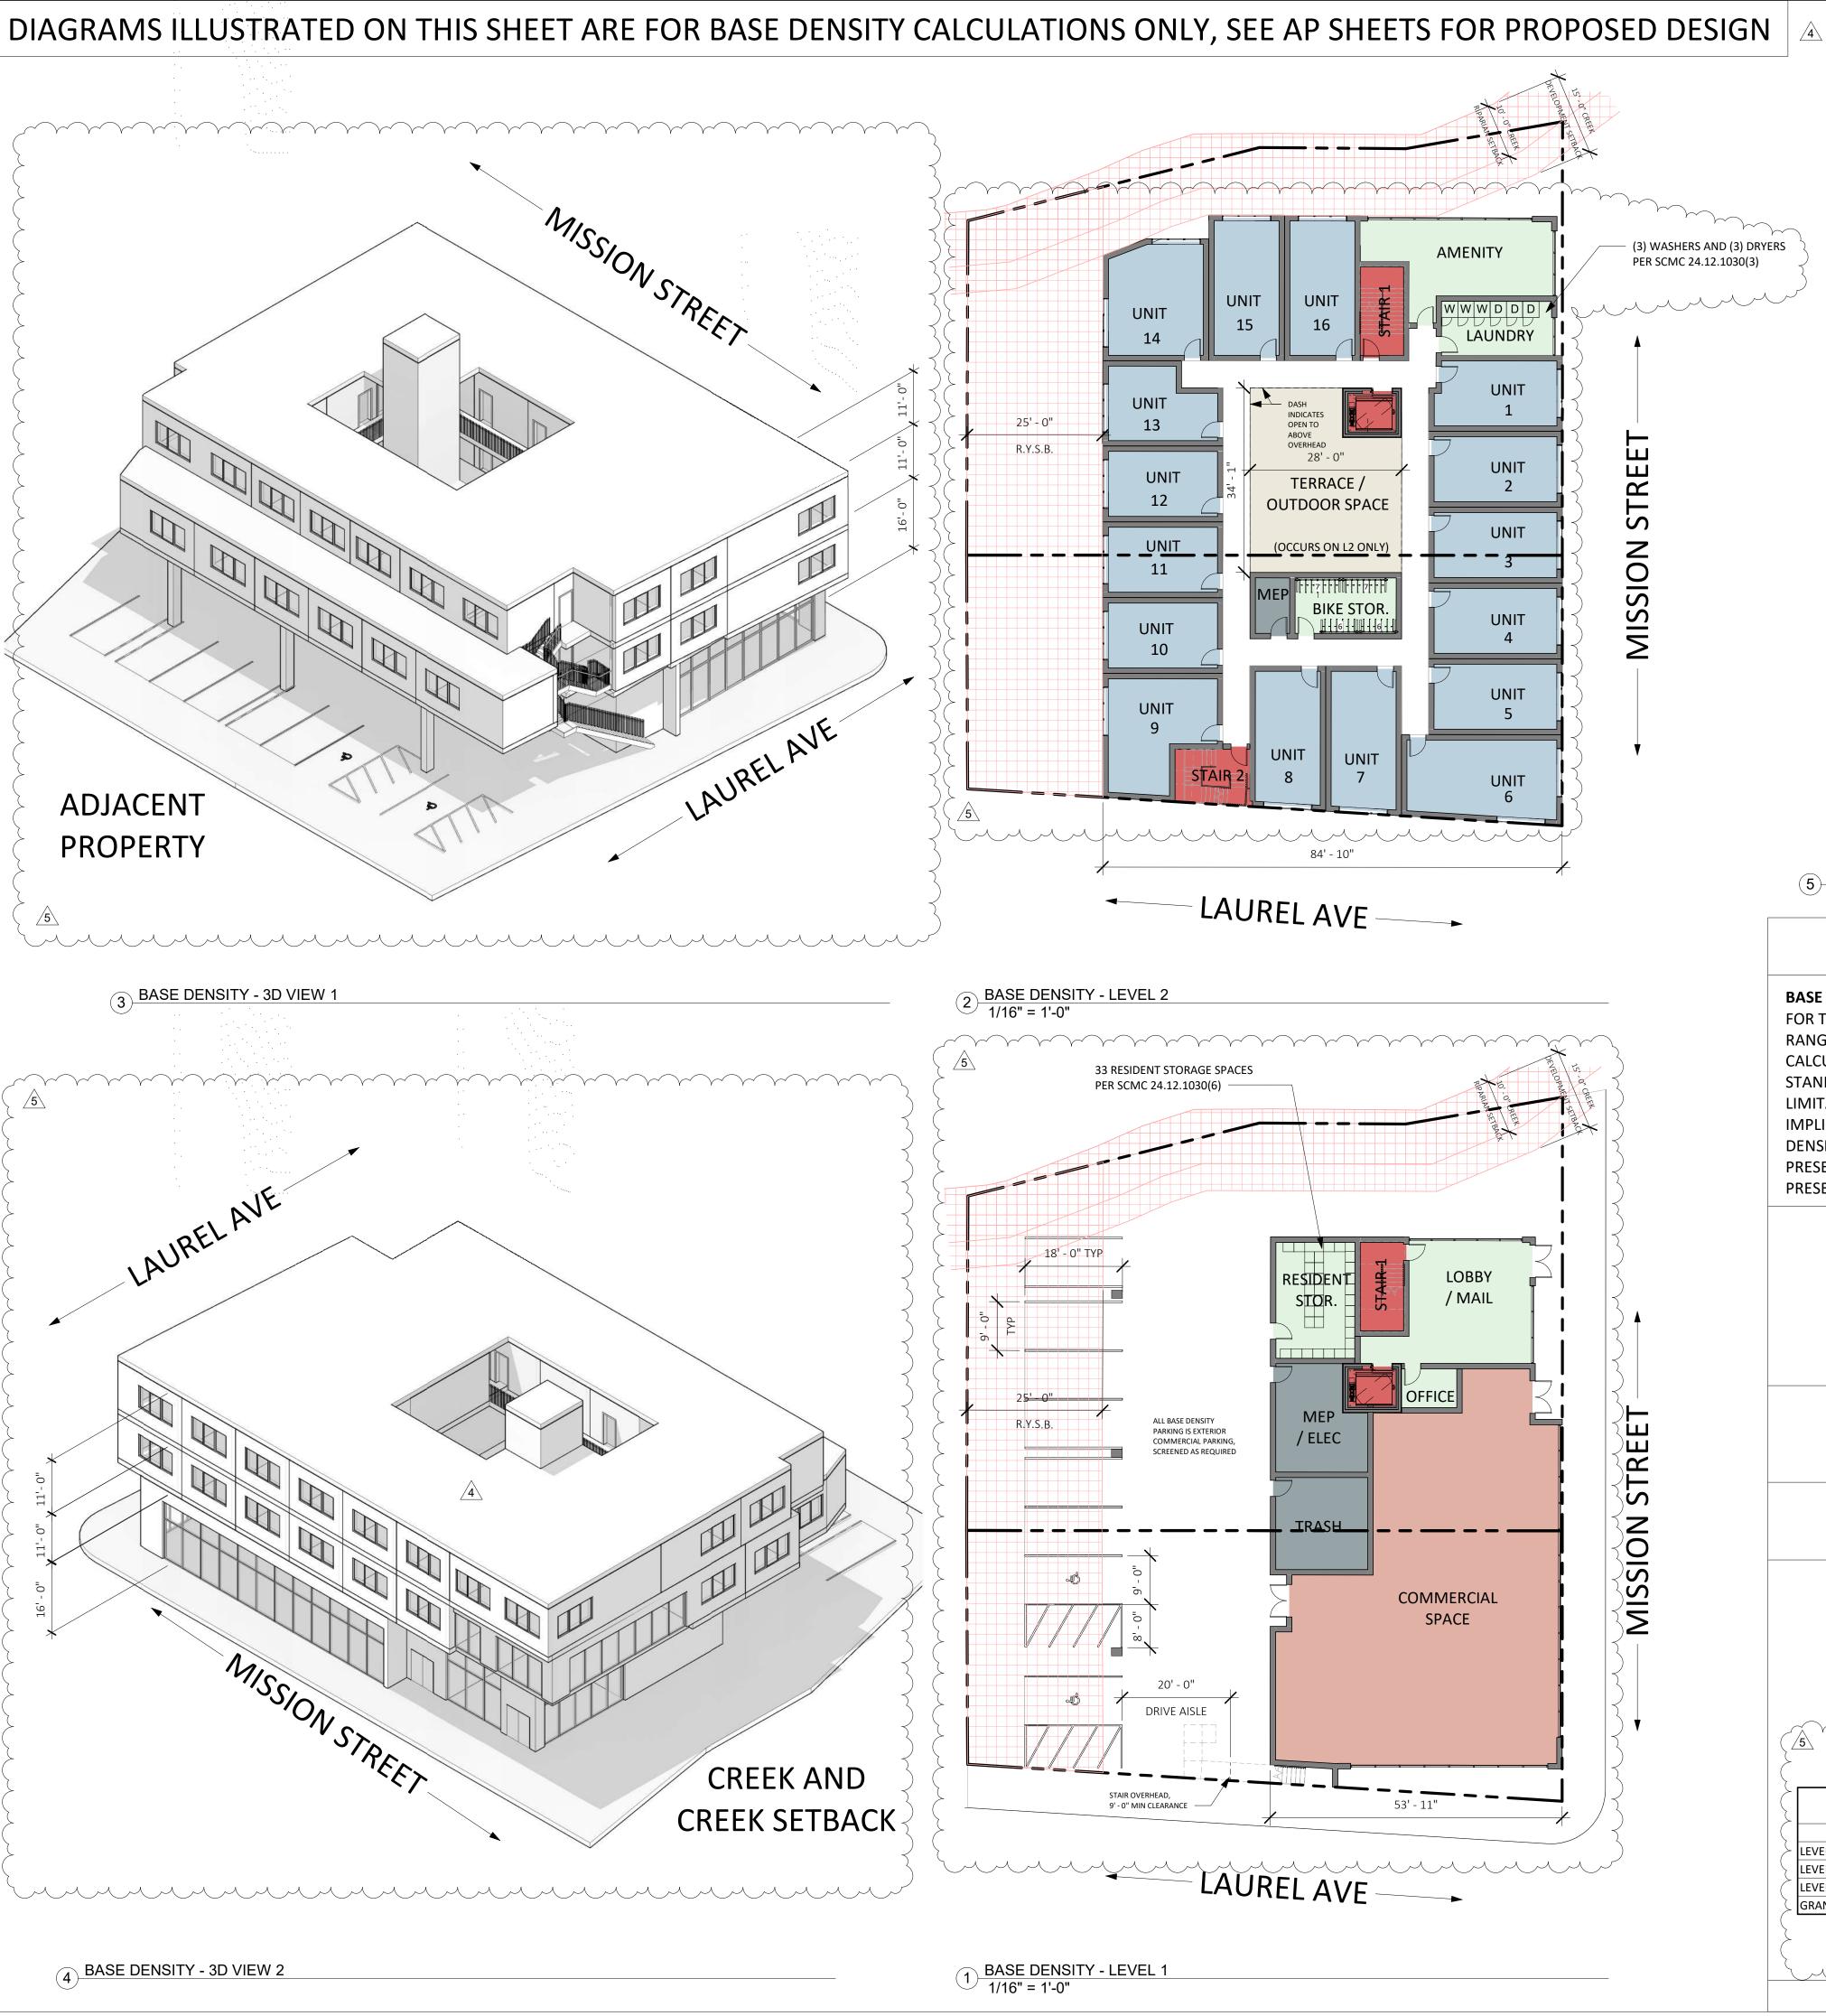



#### DENSITY BONUS UNIT CALCULATIONS

FOR THE PURPOSES OF CALCULATING THE NUMBER OF DENSITY BONUS UNITS IN AREAS WHERE A MAXIMUM DENSITY RANGE IS NOT PROVIDED IN THE ZONE DISTRICT OR GENERAL PLAN, AN IMPLICIT RESIDENTIAL DENSITY SHALL BE CALCULATED BASED ON A PROJECT PUT FORWARD BY THE APPLICANT THAT MEETS ALL APPLICABLE DEVELOPMENT STANDARDS. OBJECTIVE DEVELOPMENT STANDARDS SUCH AS SETBACKS, FLOOR AREA RATIO, AND HEIGHT LIMITATIONS, WHILE NOT DEFINING THE MAXIMUM DENSITY RANGE PER SE, CAN BE UTILIZED TO DETERMINE THE IMPLICIT RESIDENTIAL DENSITY ALLOWED. IN THIS APPROACH, A PROJECT DEFINES THE APPLICABLE RESIDENTIAL DENSITY FOR ITSELF BASED ON MEETING APPLICABLE DEVELOPMENT STANDARDS. THE AVERAGE SIZE OF THE UNITS PRESENTED IN THE BASE DENSITY PROJECT MUST BE EQUAL TO OR GREATER THAN THE AVERAGE SIZE OF THE UNITS PRESENTED IN THE DENSITY BONUS PROJECT.

#### BASE DENSITY UNITS MODELED PER OBJECTIVE STANDARDS:

- 16 UNITS ON LEVEL 2
- + 17 UNITS ON LEVEL 3
- = 33 BASE DENSITY UNITS

**BICYCLE PARKING SPACES PROVIDED (BASE DENSITY):** 

52 SPACES PROVIDED (33 REQUIRED) 854 GSF (330 GSF REQUIRED, SEE GP0.09)

#### **BONUS DENSITY UNITS CALCULATED:** 33 BASE DENSITY UNITS

- x 50% BONUS DENSITY = 17 BONUS DENSITY UNITS
- PER AB2345 (ENHANCED DENSITY BONUS)

#### **TOTAL ALLOWED UNITS:**

- 33 BASE DENSITY UNITS
- + 17 DENSITY BONUS UNITS = **50 ALLOWED UNITS**

#### **LOT AREA PER SURVEY:**

1130 MISSION: 7,187.4 SF (0.165 ACRES) 1132 MISSION: 5,314.3 SF (0.122 ACRES) 12,501.7 SF (0.287 ACRES)

**ALLOWED FAR:** 1.75

ALLOWED AREA: 21,877.98 GSF

**BASE DENSITY** 

**AVG UNIT AREA:** 354.6 GSF PER UNIT (SEE GP0.09)

BASE DENSITY - GROSS BUILDING AREA								
LEVEL	RESIDENTIAL	CIRCULATION	PARKING	AMENITY	SERVICE / MECH.	COMMERCIAL	TOTALS	
LEVEL 1	0 SF	455 SF	0 SF	1,086 SF	682 SF	3,073 SF	5,295 SF	
LEVEL 2	5,784 SF	1,173 SF	0 SF	1,887 SF	96 SF	0 SF	8,939 SF	
LEVEL 3	5,918 SF	1,138 SF	0 SF	253 SF	0 SF	0 SF	7,310 SF	
GRAND TOTALS	11,702 SF	2,766 SF	0 SF	3,226 SF	778 SF	3,073 SF	21,544 SF	

**PROPOSED BASE** 

DENSITY FAR: 1.72

**SEE AP SHEETS FOR PROPOSED BUILDING** 



189 WALNUT AVENUE SANTA CRUZ, CA 95060 WORKBENCHBUILT.COM

P: 831.227.2217

## MISSION

 $\vdash$ 

 $\vdash$ 

MISION ST. , CA 95060

1130 SANT

Issue	DESCRIPTION		DATE		
	SB330 PRE-APPLICATION				
0	0 PLANNING APPLICATION				
1	PLANNING REV-01		08.25.202		
2	PLANNING REV-02		01.04.202		
3	PLANNING REV-03		03.11.202		
4	PLANNING REV-04		04.19.202		
5	PLANNING REV-05		04.24.202		
APN	l number	006	-203-25		
Proj	ect number		21128		
Prin	t Date	01.	09.2023		
Dra	wn by		ОН		
Che		EB			
Scal	e ,	As ir	dicated		
Scal All draw	•	in constit	ndicate		


**BONUS DENSITY** EXHIBIT




A: CORNER VIEW AT INTERSECTION OF MISSION ST. AND LAUREL AVE.



**B:** MISSION STREET ELEVATION VIEW

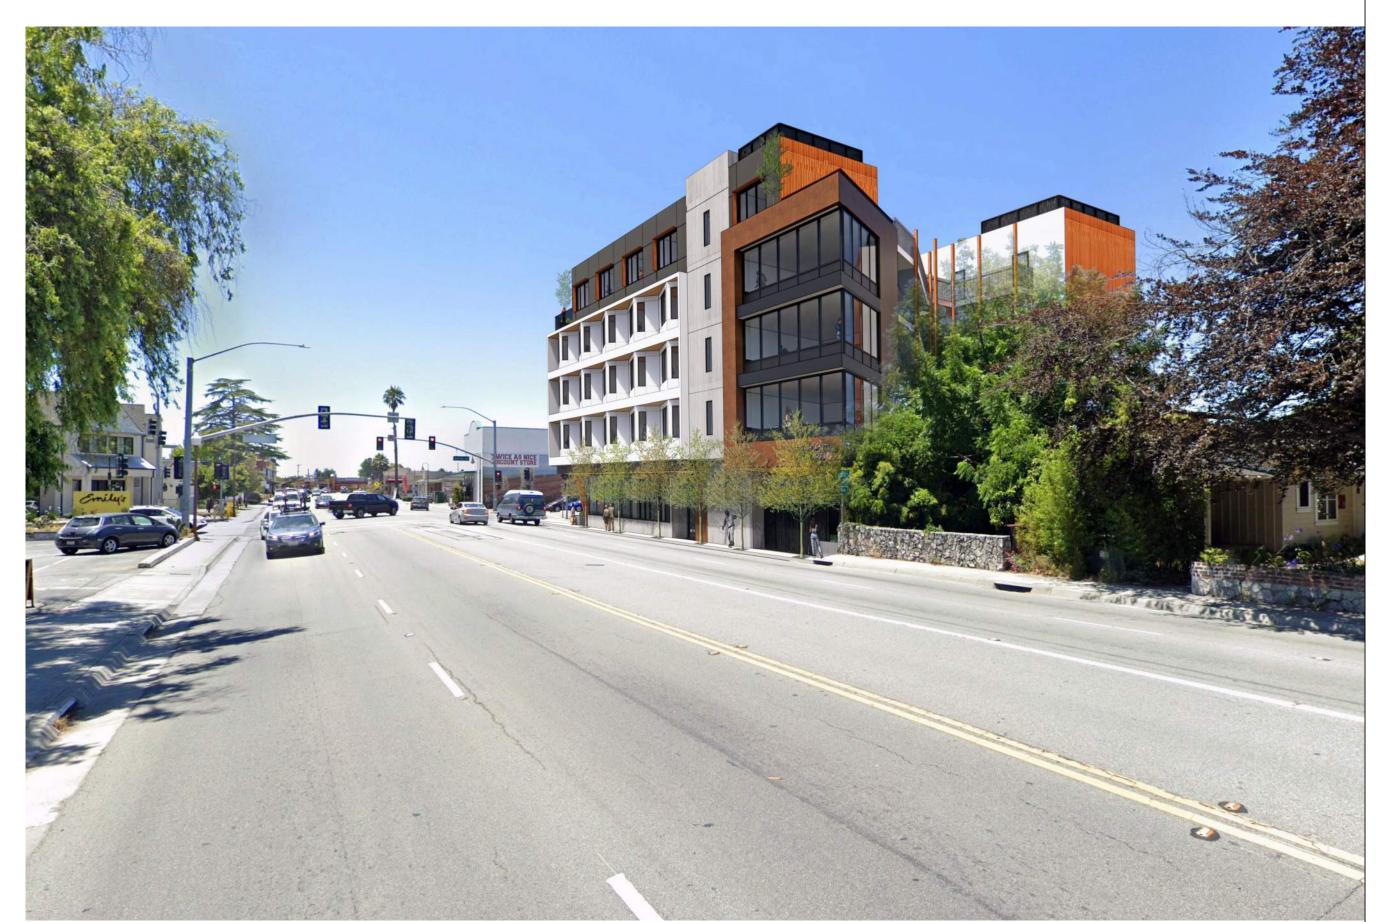

C: MISSION STREET CORNER VIEW FROM CREEK SIDE

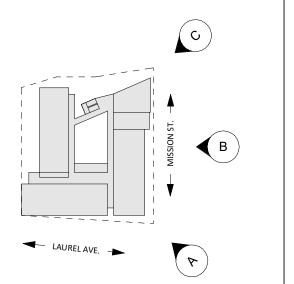



189 WALNUT AVENUE SANTA CRUZ, CA 95060 WORKBENCHBUILT.COM P: 831.227.2217

## 0 & 1132 MISSION

## MOTFORTION

Issue	DESCRIPTION	DATE
	SB330 PRE-APPLICATI	ON 01.09.202
0	PLANNING APPLICATI	ON 06.01.202
1	PLANNING REV-01	08.25.202
2	PLANNING REV-02	01.04.202
3	PLANNING REV-03	03.11.202
APN	l number	006-203-25
Pro <sub>.</sub>	ject number	21128
Prin	t Date	01.09.2023
Dra	wn by	OH
Che	cked by	EE
Sca	e	NTS

RENDERINGS AND 3D EXHIBITS

6 SOLAR STUDY - DEC 21 - 3PM

5 SOLAR STUDY - DEC 21 - 12PM

SOLAR STUDY - DEC 21 - 9AM

workbench

189 WALNUT AVENUE
SANTA CRUZ, CA 95060

SANTA CRUZ, CA 95060 WORKBENCHBUILT.COM P: 831.227.2217

## 1130 & 1132 MISSION

MISION ST. , CA 95060


1130 SANT


MOTRUCTION


Issue	DESCRIPTION	DATE
0	PLANNING APPLICATION	06.01.202
1	PLANNING REV-01	08.25.202
2	PLANNING REV-02	01.04.202
3	PLANNING REV-03	03.11.202
APN	006-203-25	
Proj	ject number	21128
Prin	t Date	01.09.2023
Dra	wn by	ME
Che	cked by	EB
Scal	le	NTS

SHADOW STUDY

#### PROPOSED GROSS BUILDING AREA PLANS

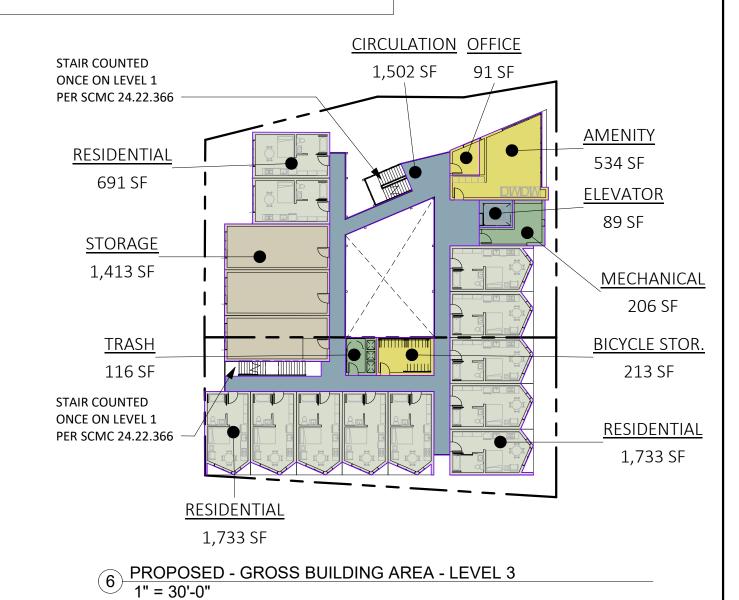


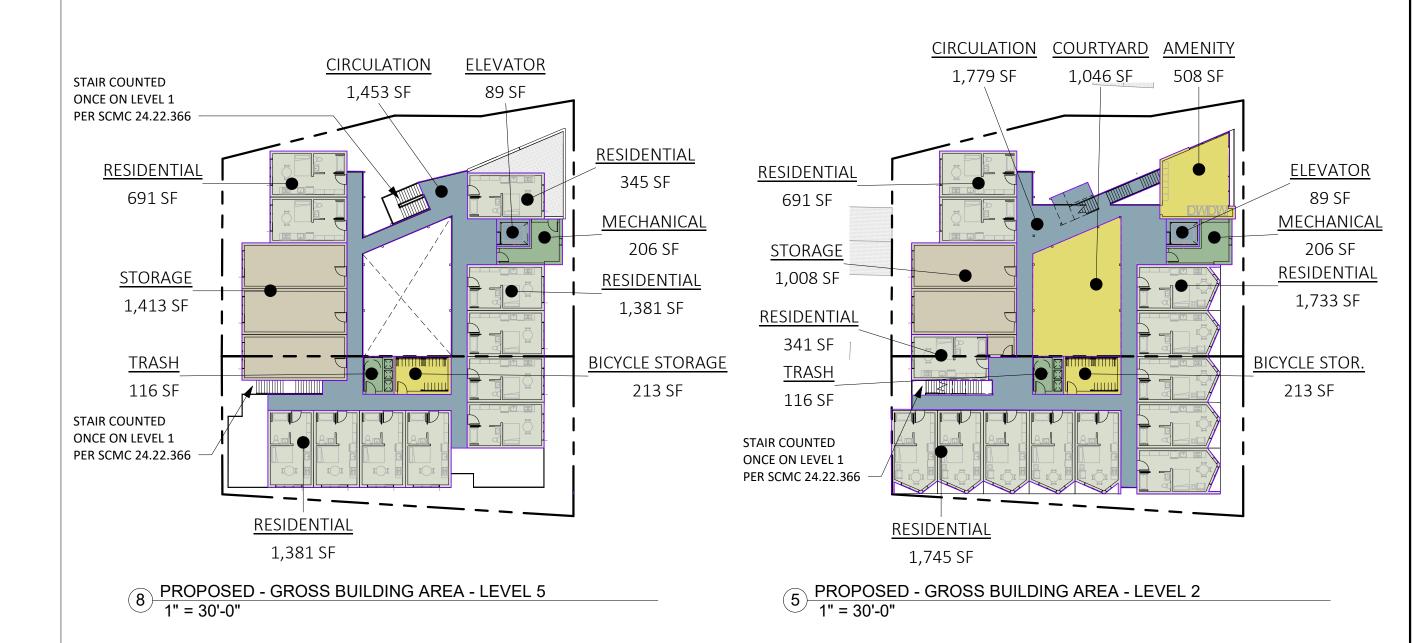

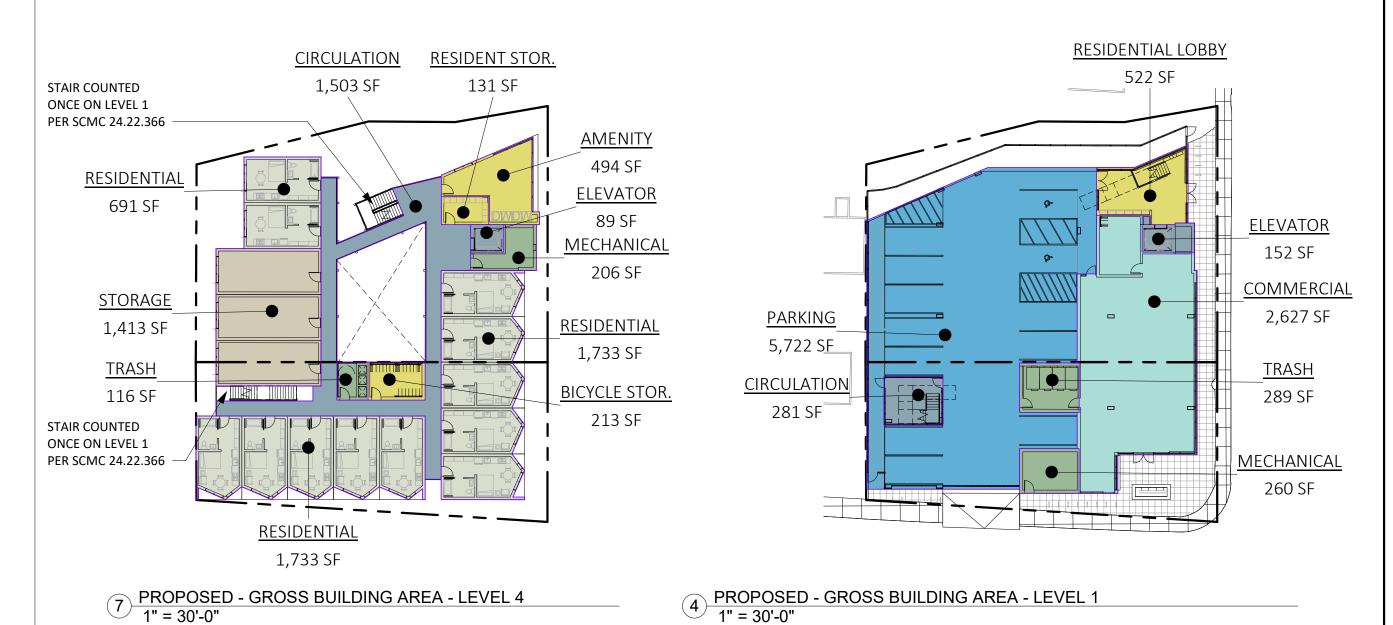



	PROPOSED - GROSS BUILDING AREA									
LEVEL	RESIDENTIAL	CIRCULATION	PARKING	AMENITY	SERVICE / MECH.	COMMERCIAL	STORAGE	TOTALS		
LEVEL 1	0 SF	433 SF	5,722 SF	522 SF	549 SF	2,627 SF	0 SF	9,853 SF		
LEVEL 2	4,510 SF	1,868 SF	0 SF	1,767 SF	322 SF	0 SF	1,008 SF	9,475 SF		
LEVEL 3	4,157 SF	1,591 SF	0 SF	838 SF	322 SF	0 SF	1,413 SF	8,321 SF		
LEVEL 4	4,157 SF	1,592 SF	0 SF	838 SF	322 SF	0 SF	1,413 SF	8,322 SF		
LEVEL 5	3,798 SF	1,542 SF	0 SF	213 SF	322 SF	0 SF	1,413 SF	7,288 SF		
GRAND TOTALS	16,622 SF	7,026 SF	5,722 SF	4,178 SF	1,837 SF	2,627 SF	5,247 SF	43,259 SF		

#### BASE DENSITY GROSS BUILDING AREA PLANS

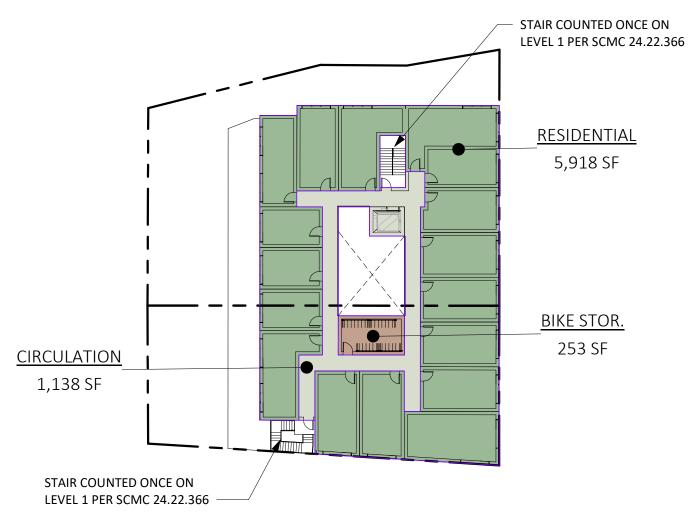

BASE DENSITY - GROSS BUILDING AREA - LEVEL 3
1" = 30'-0"

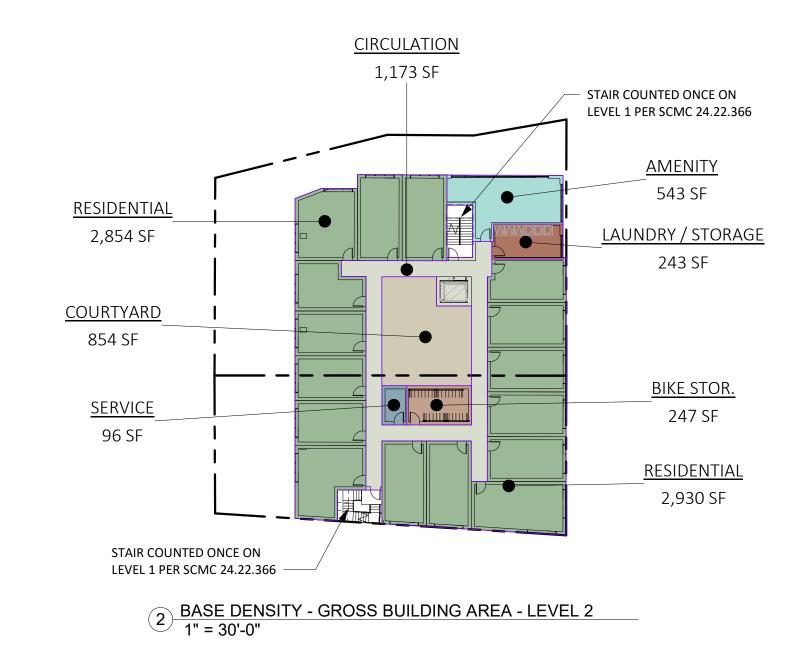

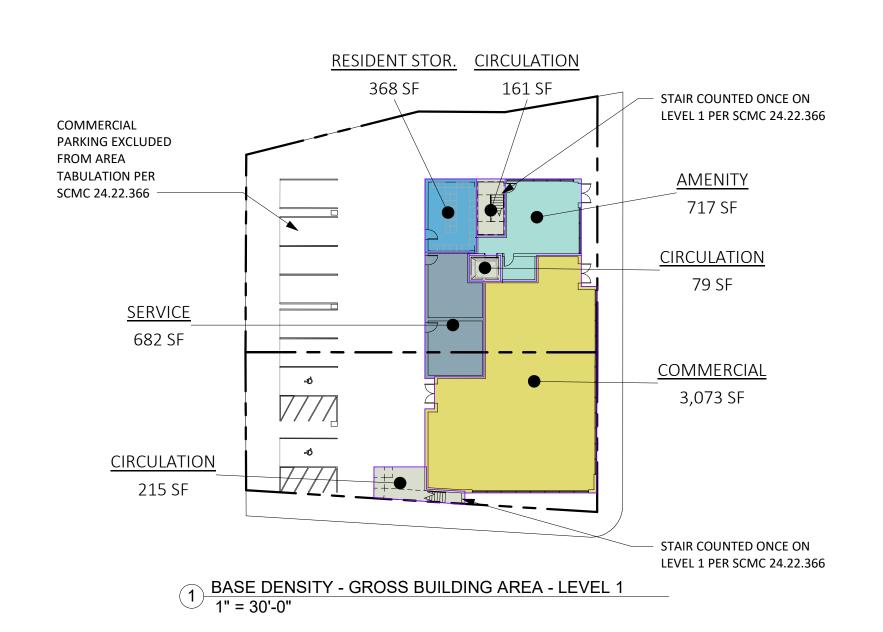

	BASE DENSITY - GROSS BUILDING AREA						
LEVEL	RESIDENTIAL	CIRCULATION	PARKING	AMENITY	SERVICE / MECH.	COMMERCIAL	TOTALS
LEVEL 1	0 SF	455 SF	0 SF	1,086 SF	682 SF	3,073 SF	5,295 SF
LEVEL 2	5,784 SF	1,173 SF	0 SF	1,887 SF	96 SF	0 SF	8,939 SF
LEVEL 3	5,918 SF	1,138 SF	0 SF	253 SF	0 SF	0 SF	7,310 SF
GRAND TOTALS	11,702 SF	2,766 SF	0 SF	3,226 SF	778 SF	3,073 SF	21,544 SF

## AVERAGE GROSS RESIDENTIAL UNIT SIZE:

SCMC 24.16.255 (6):

FOR THE PURPOSES OF CALCULATING THE NUMBER OF DENSITY BONUS UNITS IN AREAS WHERE A MAXIMUM DENSITY RANGE IS NOT PROVIDED IN THE ZONE DISTRICT OR GENERAL PLAN, AN IMPLICIT RESIDENTIAL DENSITY SHALL BE CALCULATED BASED ON A PROJECT PUT FORWARD BY THE APPLICANT THAT MEETS ALL APPLICABLE DEVELOPMENT STANDARDS. OBJECTIVE DEVELOPMENT STANDARDS SUCH AS SETBACKS, FLOOR AREA RATIO, AND HEIGHT LIMITATIONS, WHILE NOT DEFINING THE MAXIMUM DENSITY RANGE PER SE, CAN BE UTILIZED TO DETERMINE THE IMPLICIT RESIDENTIAL DENSITY ALLOWED. IN THIS APPROACH, A PROJECT DEFINES THE APPLICABLE RESIDENTIAL DENSITY FOR ITSELF BASED ON MEETING APPLICABLE DEVELOPMENT STANDARDS. THE AVERAGE SIZE OF THE UNITS PRESENTED IN THE BASE DENSITY PROJECT MUST BE EQUAL TO OR GREATER THAN THE AVERAGE SIZE OF THE UNITS PRESENTED IN THE DENSITY BONUS PROJECT.

PROPOSED PROJECT:

PROPOSED GROSS
RESIDENTIAL AREA: 16,622 GSF

PROPOSED UNIT COUNT:

UNT: 48 UNITS

346.3 GSF

33 UNITS

AVERAGE GROSS

UNIT SIZE:

**BASE DENSITY:** 

BASE DENSITY GROSS

RESIDENTIAL AREA: 11,702 GSF

BASE DENSITY UNIT COUNT:

AVERAGE GROSS

UNIT SIZE: 354.6 GSF

workbench

189 WALNUT AVENUE SANTA CRUZ, CA 95060 WORKBENCHBUILT.COM P: 831.227.2217

2 MISSION

3

1130 & 1130 & 1130 & SANTA CRU

MISION ST., , CA 95060

7 7

ISSUES/ REVISIONS DESCRIPTION DATE PLANNING REV-05 04.24.2024 006-203-25 APN number 21128 Project number 01.09.2023 Print Date Drawn by ОН ΕB Checked by 1" = 30'-0" All drawings and written material appearing herin constitute original and unpublished work of Workbench, Inc. and may not be duplicated, used or disclosed without written consent of the Workbench. Inc.


GROSS AREA PLAN EXHIBITS

GP0.09


#### PROPOSED NET UNIT AREA PLANS




6 PROPOSED - NET UNIT AREA - LEVEL 5 1" = 20'-0"

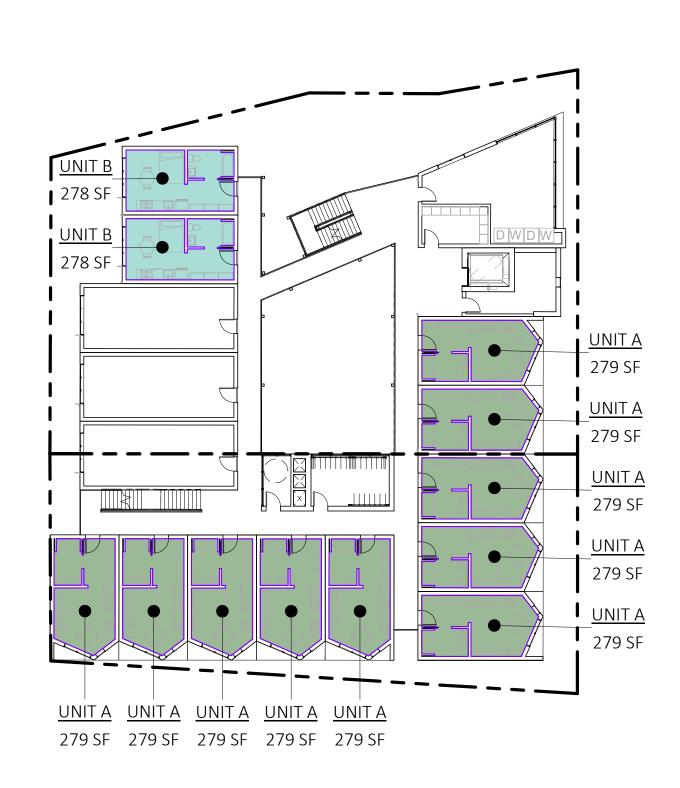

5 PROPOSED - NET UNIT AREA - LEVEL 4
1" = 20'-0"

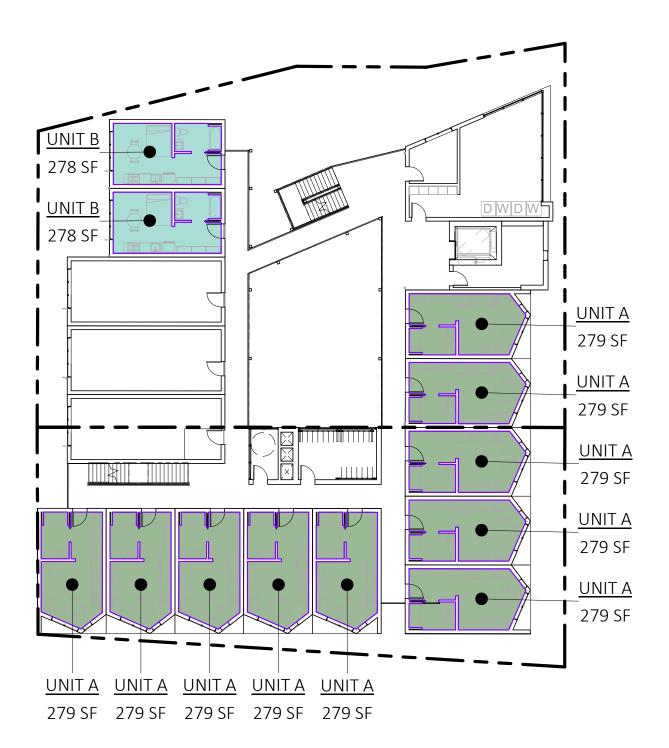


PROPOSED - NET UNIT AREA - LEVEL 3
1" = 20'-0"

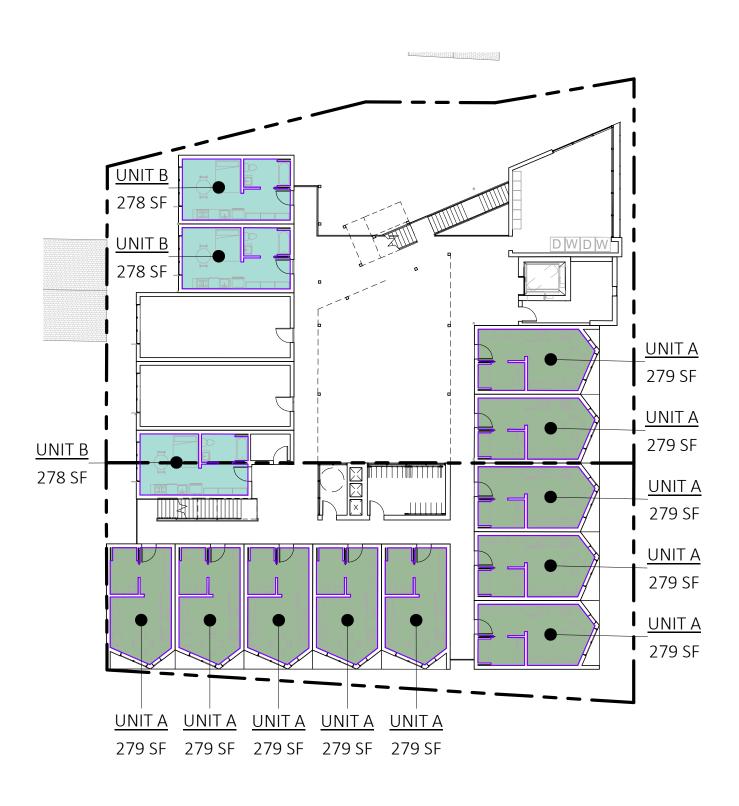


3 PROPOSED - NET UNIT AREA - LEVEL 2 1" = 20'-0"

PROPOSED	- AVERAGE N	IET UNIT AREA
TOTAL NET UNIT AREA	COUNT	AVERAGE NET UNIT AREA
13,387 SF	48	278.9

#### BASE DENSITY NET UNIT AREA PLANS

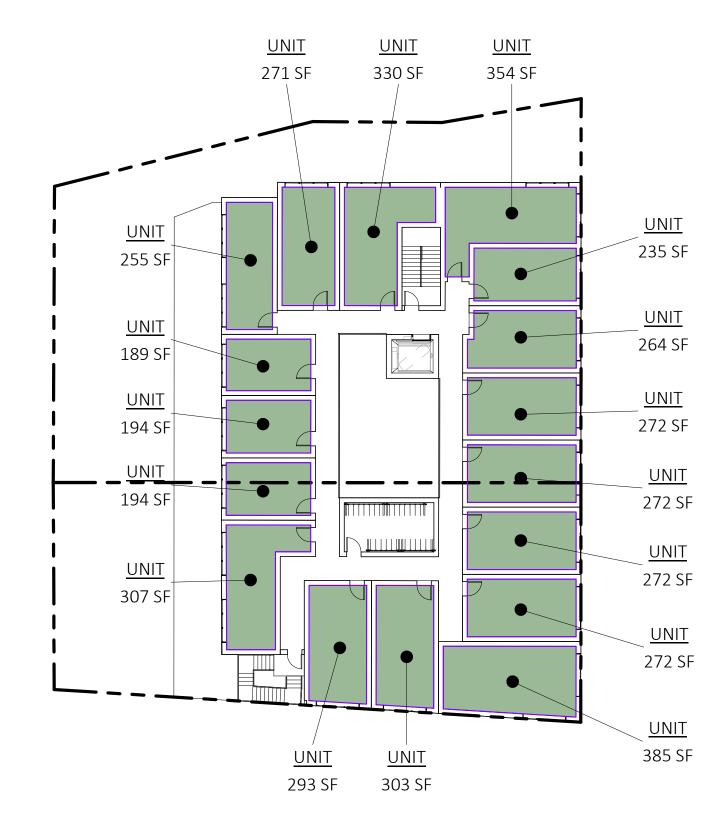

2 BASE DENSITY - NET UNIT AREA - LEVEL 3
1" = 20'-0"

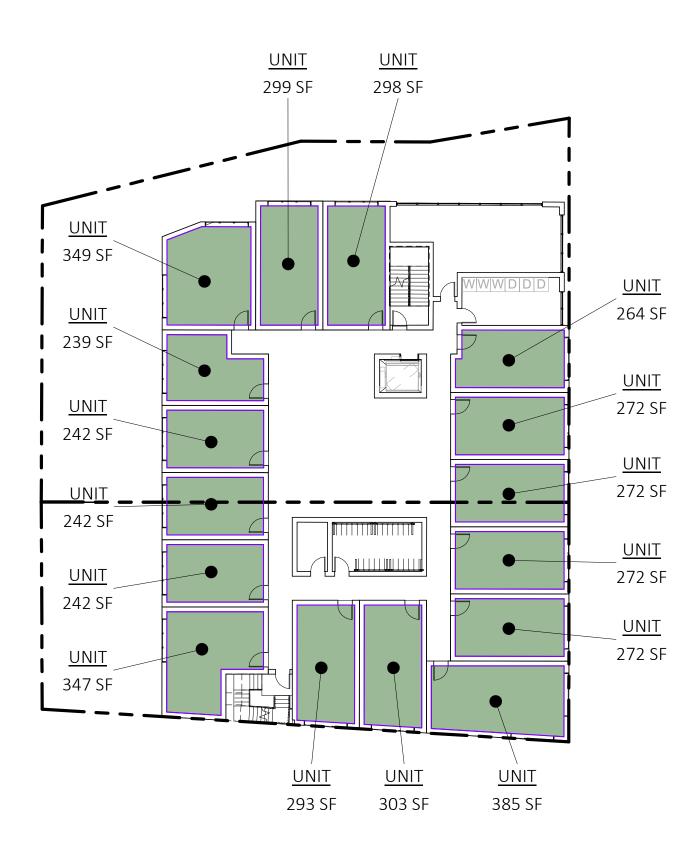

1 BASE DENSITY - NET UNIT AREA - LEVEL 2
1" = 20'-0"

BASE DENSITY -	AVERAGE N	ET UNIT AREA
TOTAL NET UNIT AREA	COUNT	AVERAGE NET AREA
9,250 SF	33	280.3

#### **AVERAGE NET RESIDENTIAL UNIT SIZE:**

**SCMC 24.12.1010**:

THE NET AREA OF A SRO UNIT MAY RANGE FROM A MINIMUM OF ONE HUNDRED FIFTY SQUARE FEET TO A MAXIMUM OF FOUR HUNDRED SQUARE FEET, WITH THE AVERAGE UNIT SIZE BEING NO GREATER THAN THREE HUNDRED FORTY-FIVE SQUARE FEET.

**PROPOSED PROJECT:** PROPOSED NET

**RESIDENTIAL AREA:** 13,387 NSF

PROPOSED UNIT

**AVERAGE NET** 

48 UNITS

278.9 NSF **UNIT SIZE:** 

**BASE DENSITY:** BASE DENSITY NET

**BASE DENSITY** 

COUNT:

9,250 NSF RESIDENTIAL AREA:

**UNIT COUNT:** 33 UNITS

**AVERAGE NET** 280.3 NSF **UNIT SIZE:** 

workbench

189 WALNUT AVENUE SANTA CRUZ, CA 95060 WORKBENCHBUILT.COM

P: 831.227.2217

MISSION 7  $\mathcal{C}$  $\vdash$ 

8

 $\vdash$ 

1130 SANT

MISION ST. , CA 95060


7 7

ISSUES/ REVISIONS DESCRIPTION DATE PLANNING REV-05 04.24.2024 006-203-25 APN number 21128 Project number 01.09.2023 Print Date Drawn by ОН ΕB Checked by 1" = 20'-0"

NET UNIT AREA PLAN **EXHIBITS** 

All drawings and written material appearing herin constitute original and unpublished work of Workbench, Inc. and may not be duplicated, used or

disclosed without written consent of the Workbench, Inc.

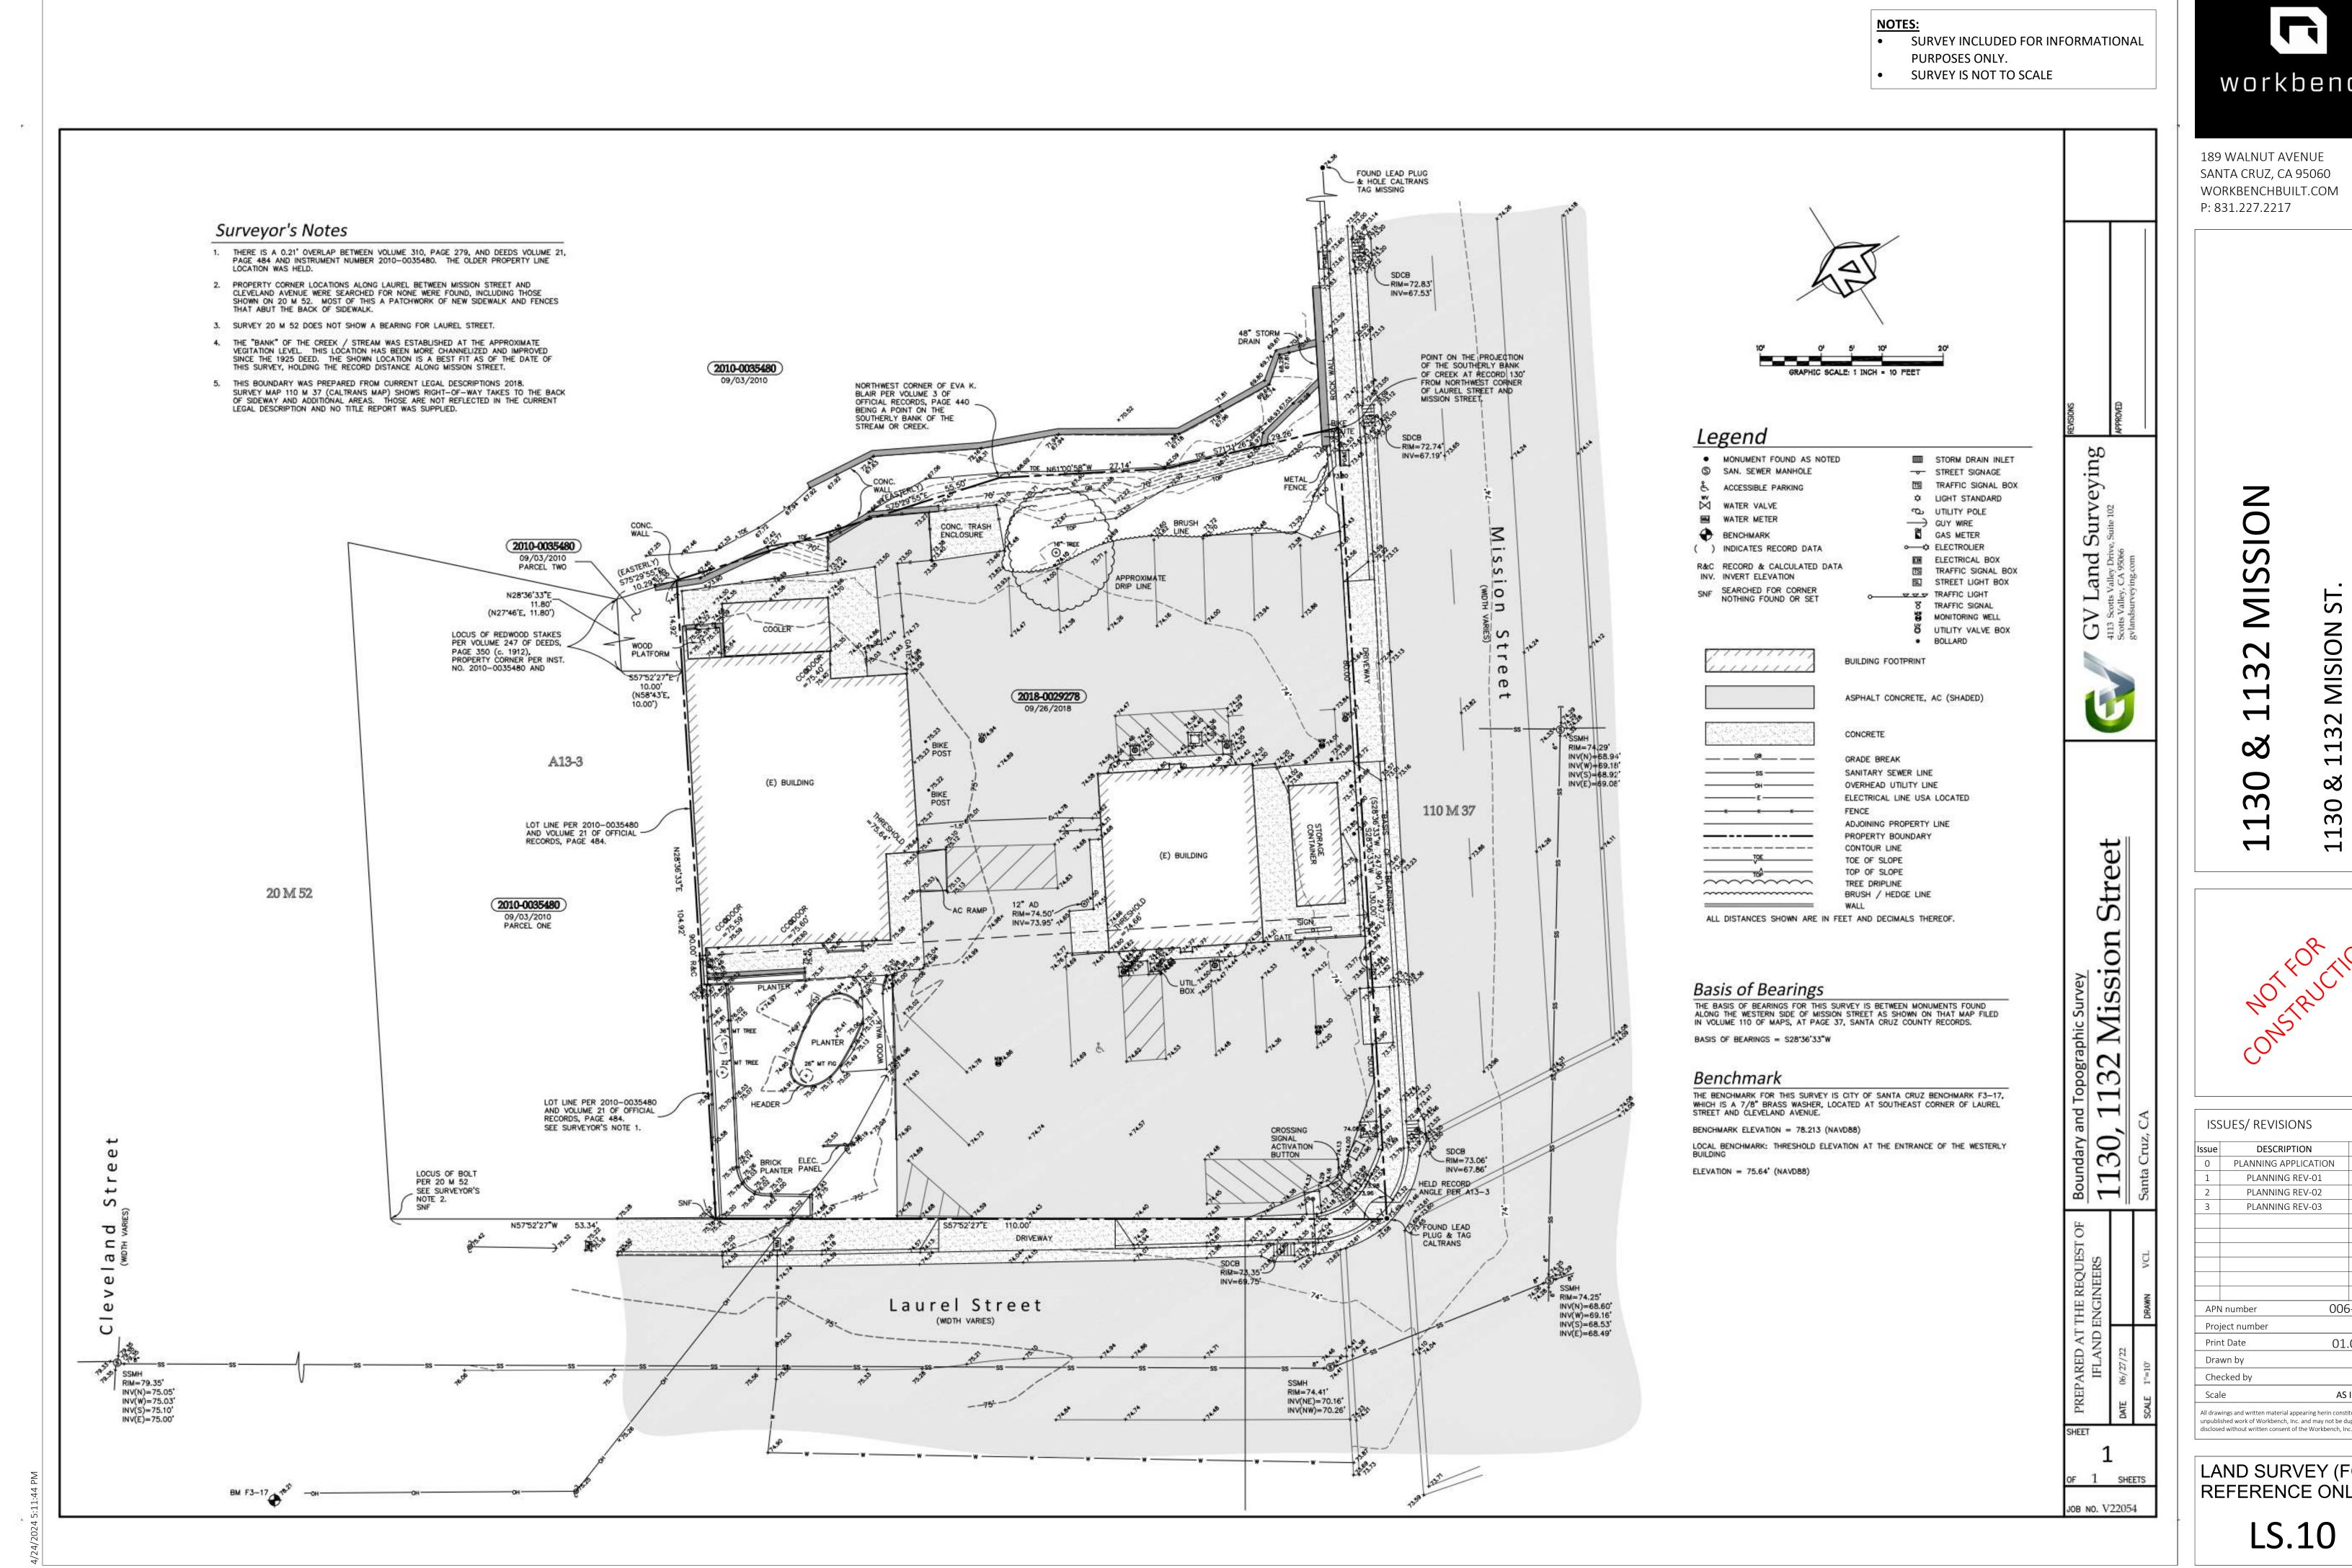



189 WALNUT AVENUE SANTA CRUZ, CA 95060 WORKBENCHBUILT.COM P: 831.227.2217

<u>S</u>10 MIS 3

S

0905

6


MISION

## 30 $\Box$ $\vdash$

ISS	SUES/ REVISIONS	
ssue	DESCRIPTION	DATE
0	PLANNING APPLICATION	06.01.2023
1	PLANNING REV-01	08.25.2023
2	PLANNING REV-02	01.04.2024
3	PLANNING REV-03	03.11.2024
APN	I number 006	5-203-25
Proj	ect number	21128
Prin	t Date 01.	09.2023
Dra	wn by	DS
Che	cked by	EB
Scal	e <b>AS</b>	INDICATED
	vings and written material appearing herin consti shed work of Workbench, Inc. and may not be du	-

LAND SURVEY (FOR REFERENCE ONLY)

LS.10

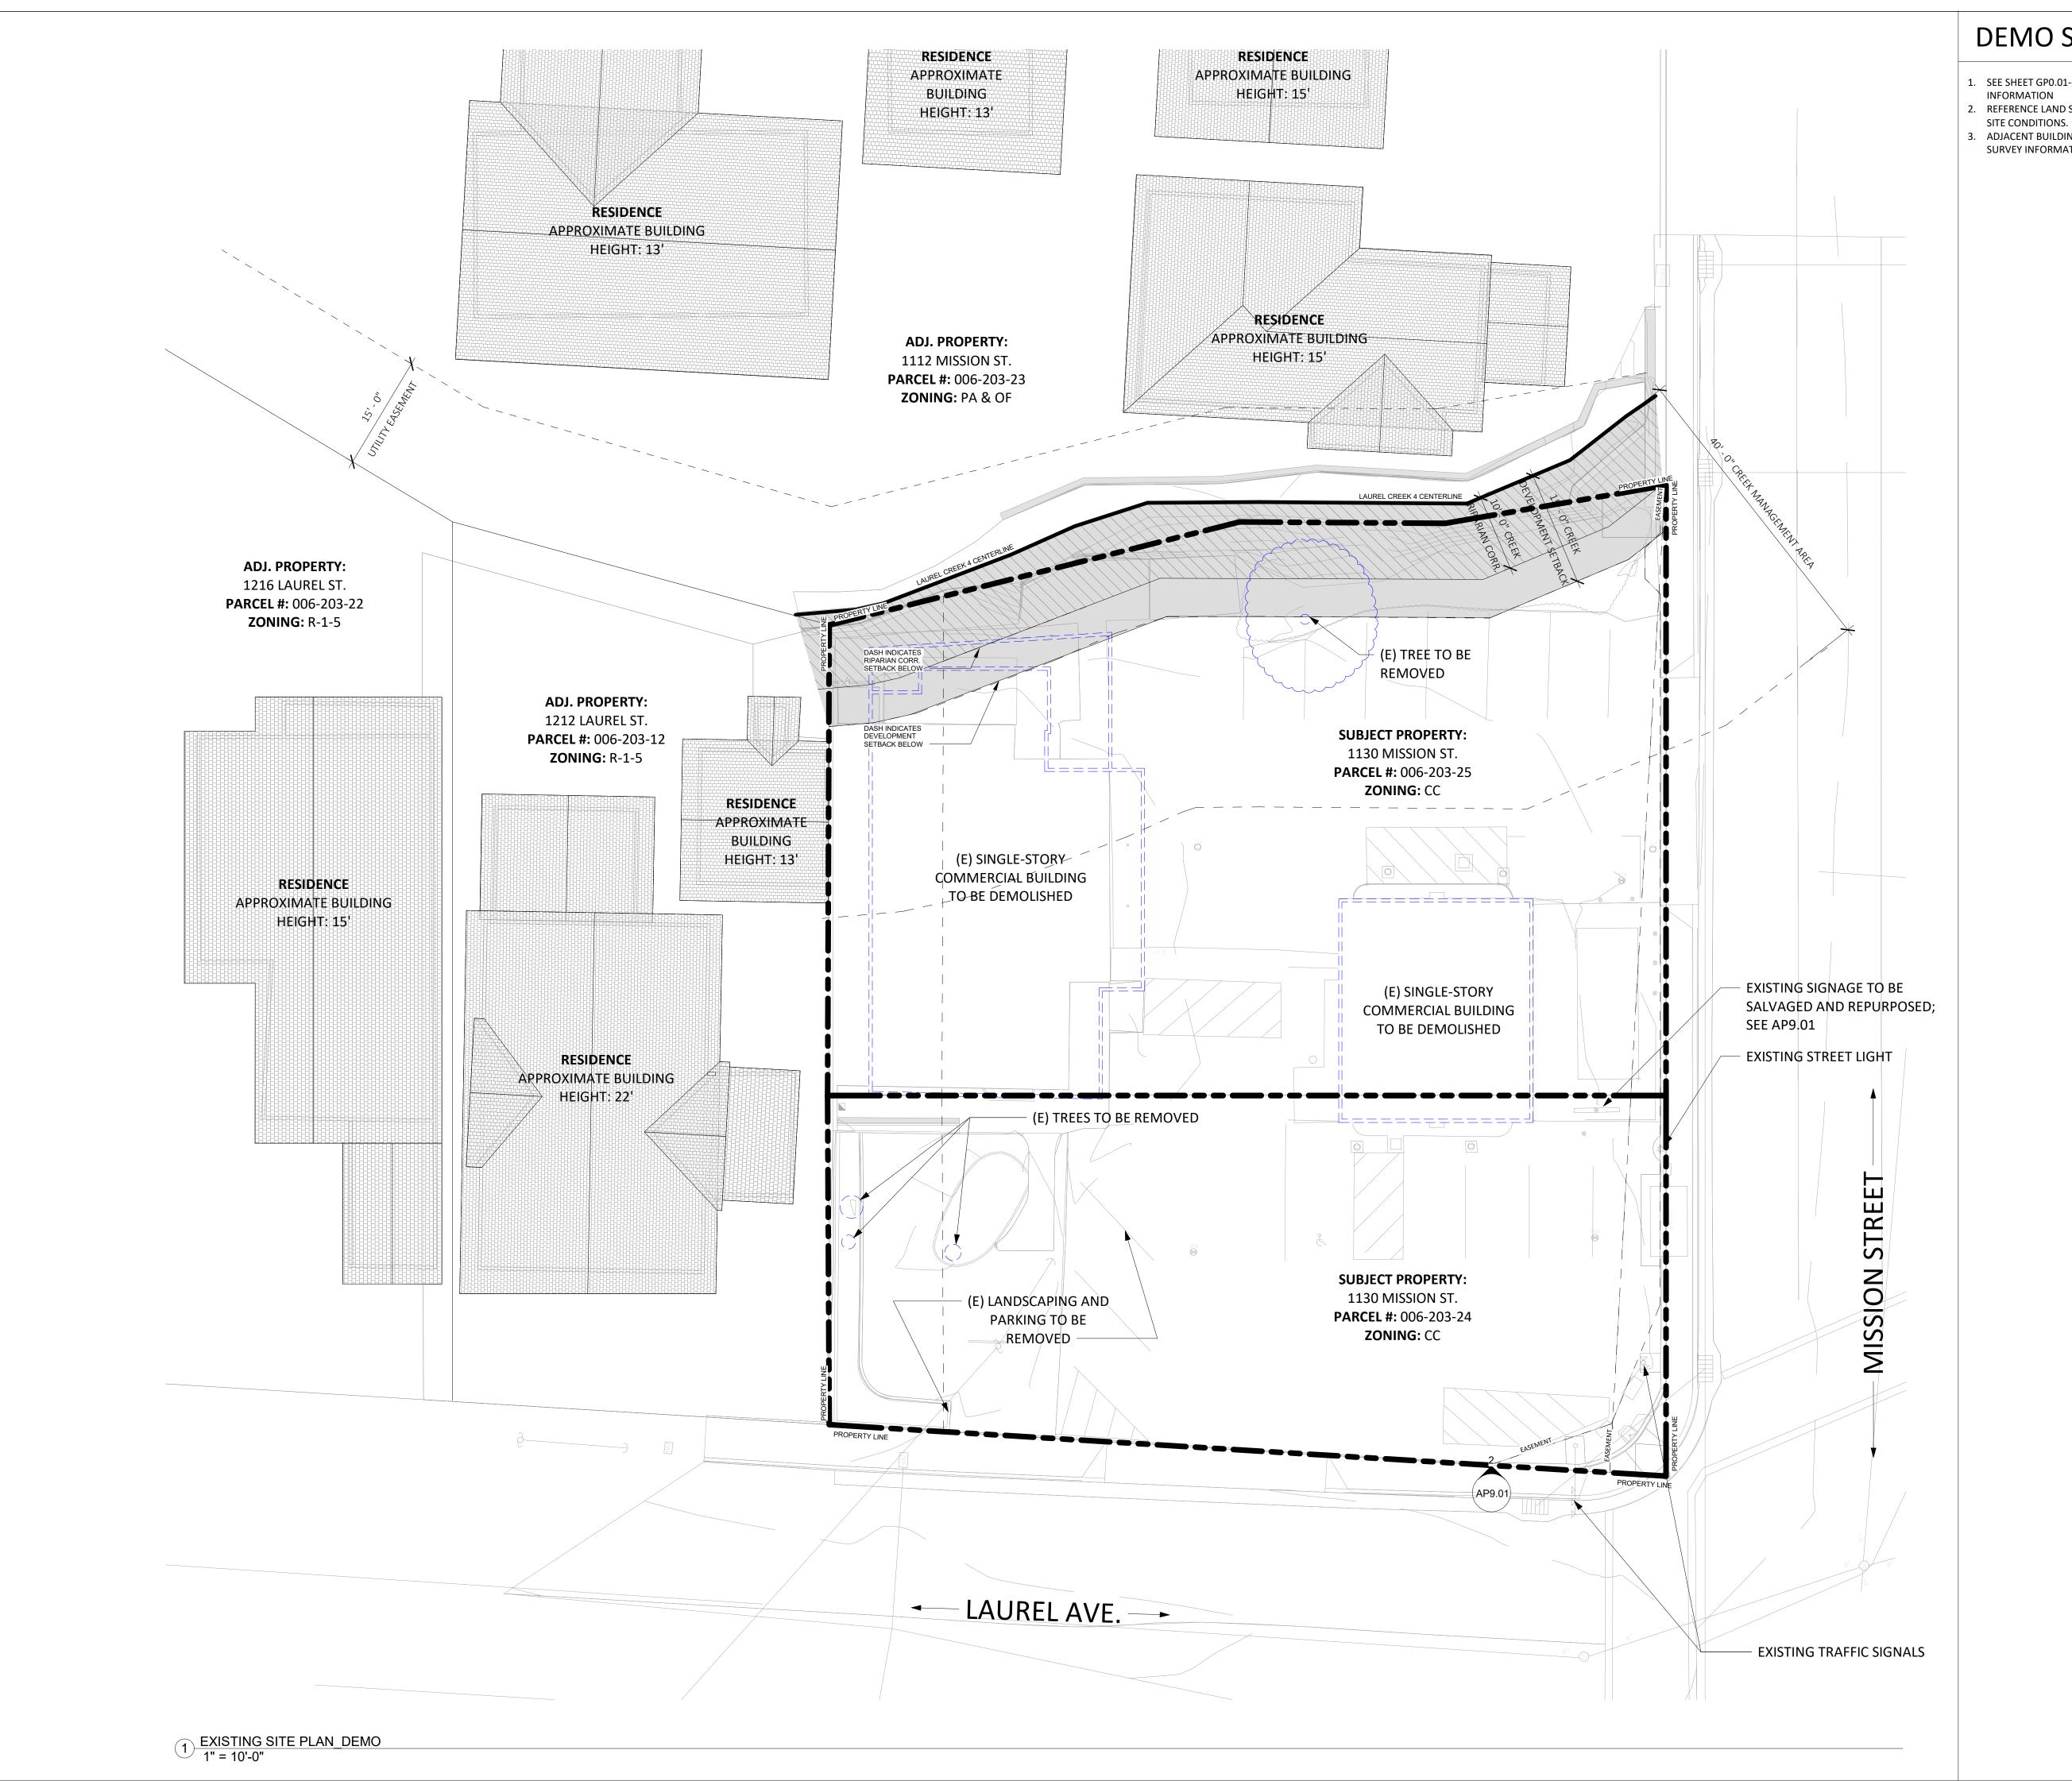

#### **DEMO SITE PLAN NOTES**

- 1. SEE SHEET GP0.01-GP0.05 FOR GENERAL NOTES AND PROJECT
- 2. REFERENCE LAND SURVEY FOR SITE ELEVATIONS, SLOPES AND EXISTING
- 3. ADJACENT BUILDING HEIGHTS ARE SHOWN APPROXIMATELY BASED ON SURVEY INFORMATION AND GOOGLE EARTH MEASUREMENTS.



189 WALNUT AVENUE SANTA CRUZ, CA 95060 WORKBENCHBUILT.COM

## P: 831.227.2217

### MISSION 7 $\mathcal{C}$ $\vdash$ 8 0 113

MISION ST. , CA 95060

1130 SANT




	330 PRE-APPLICA ANNING APPLICA PLANNING REV- PLANNING REV- PLANNING REV-	ATION 01 02	01.09.202 06.01.202 08.25.202 01.04.202 03.11.202
1 2	PLANNING REV- PLANNING REV-	01	08.25.202
2	PLANNING REV-	02	01.04.202
			01.0201
3	PLANNING REV-	03	03.11.202
		000	202.25
APN num	ber	006	5-203-25
Project n	umber		21128
Print Date	9	01.	.09.2023
Drawn by	,		OH
Checked	by		EB
Scale		As ir	ndicated

PROPOSED DEMO SITE PLAN

TRUE PROJECT

NORTH NORTH

AP0.50D

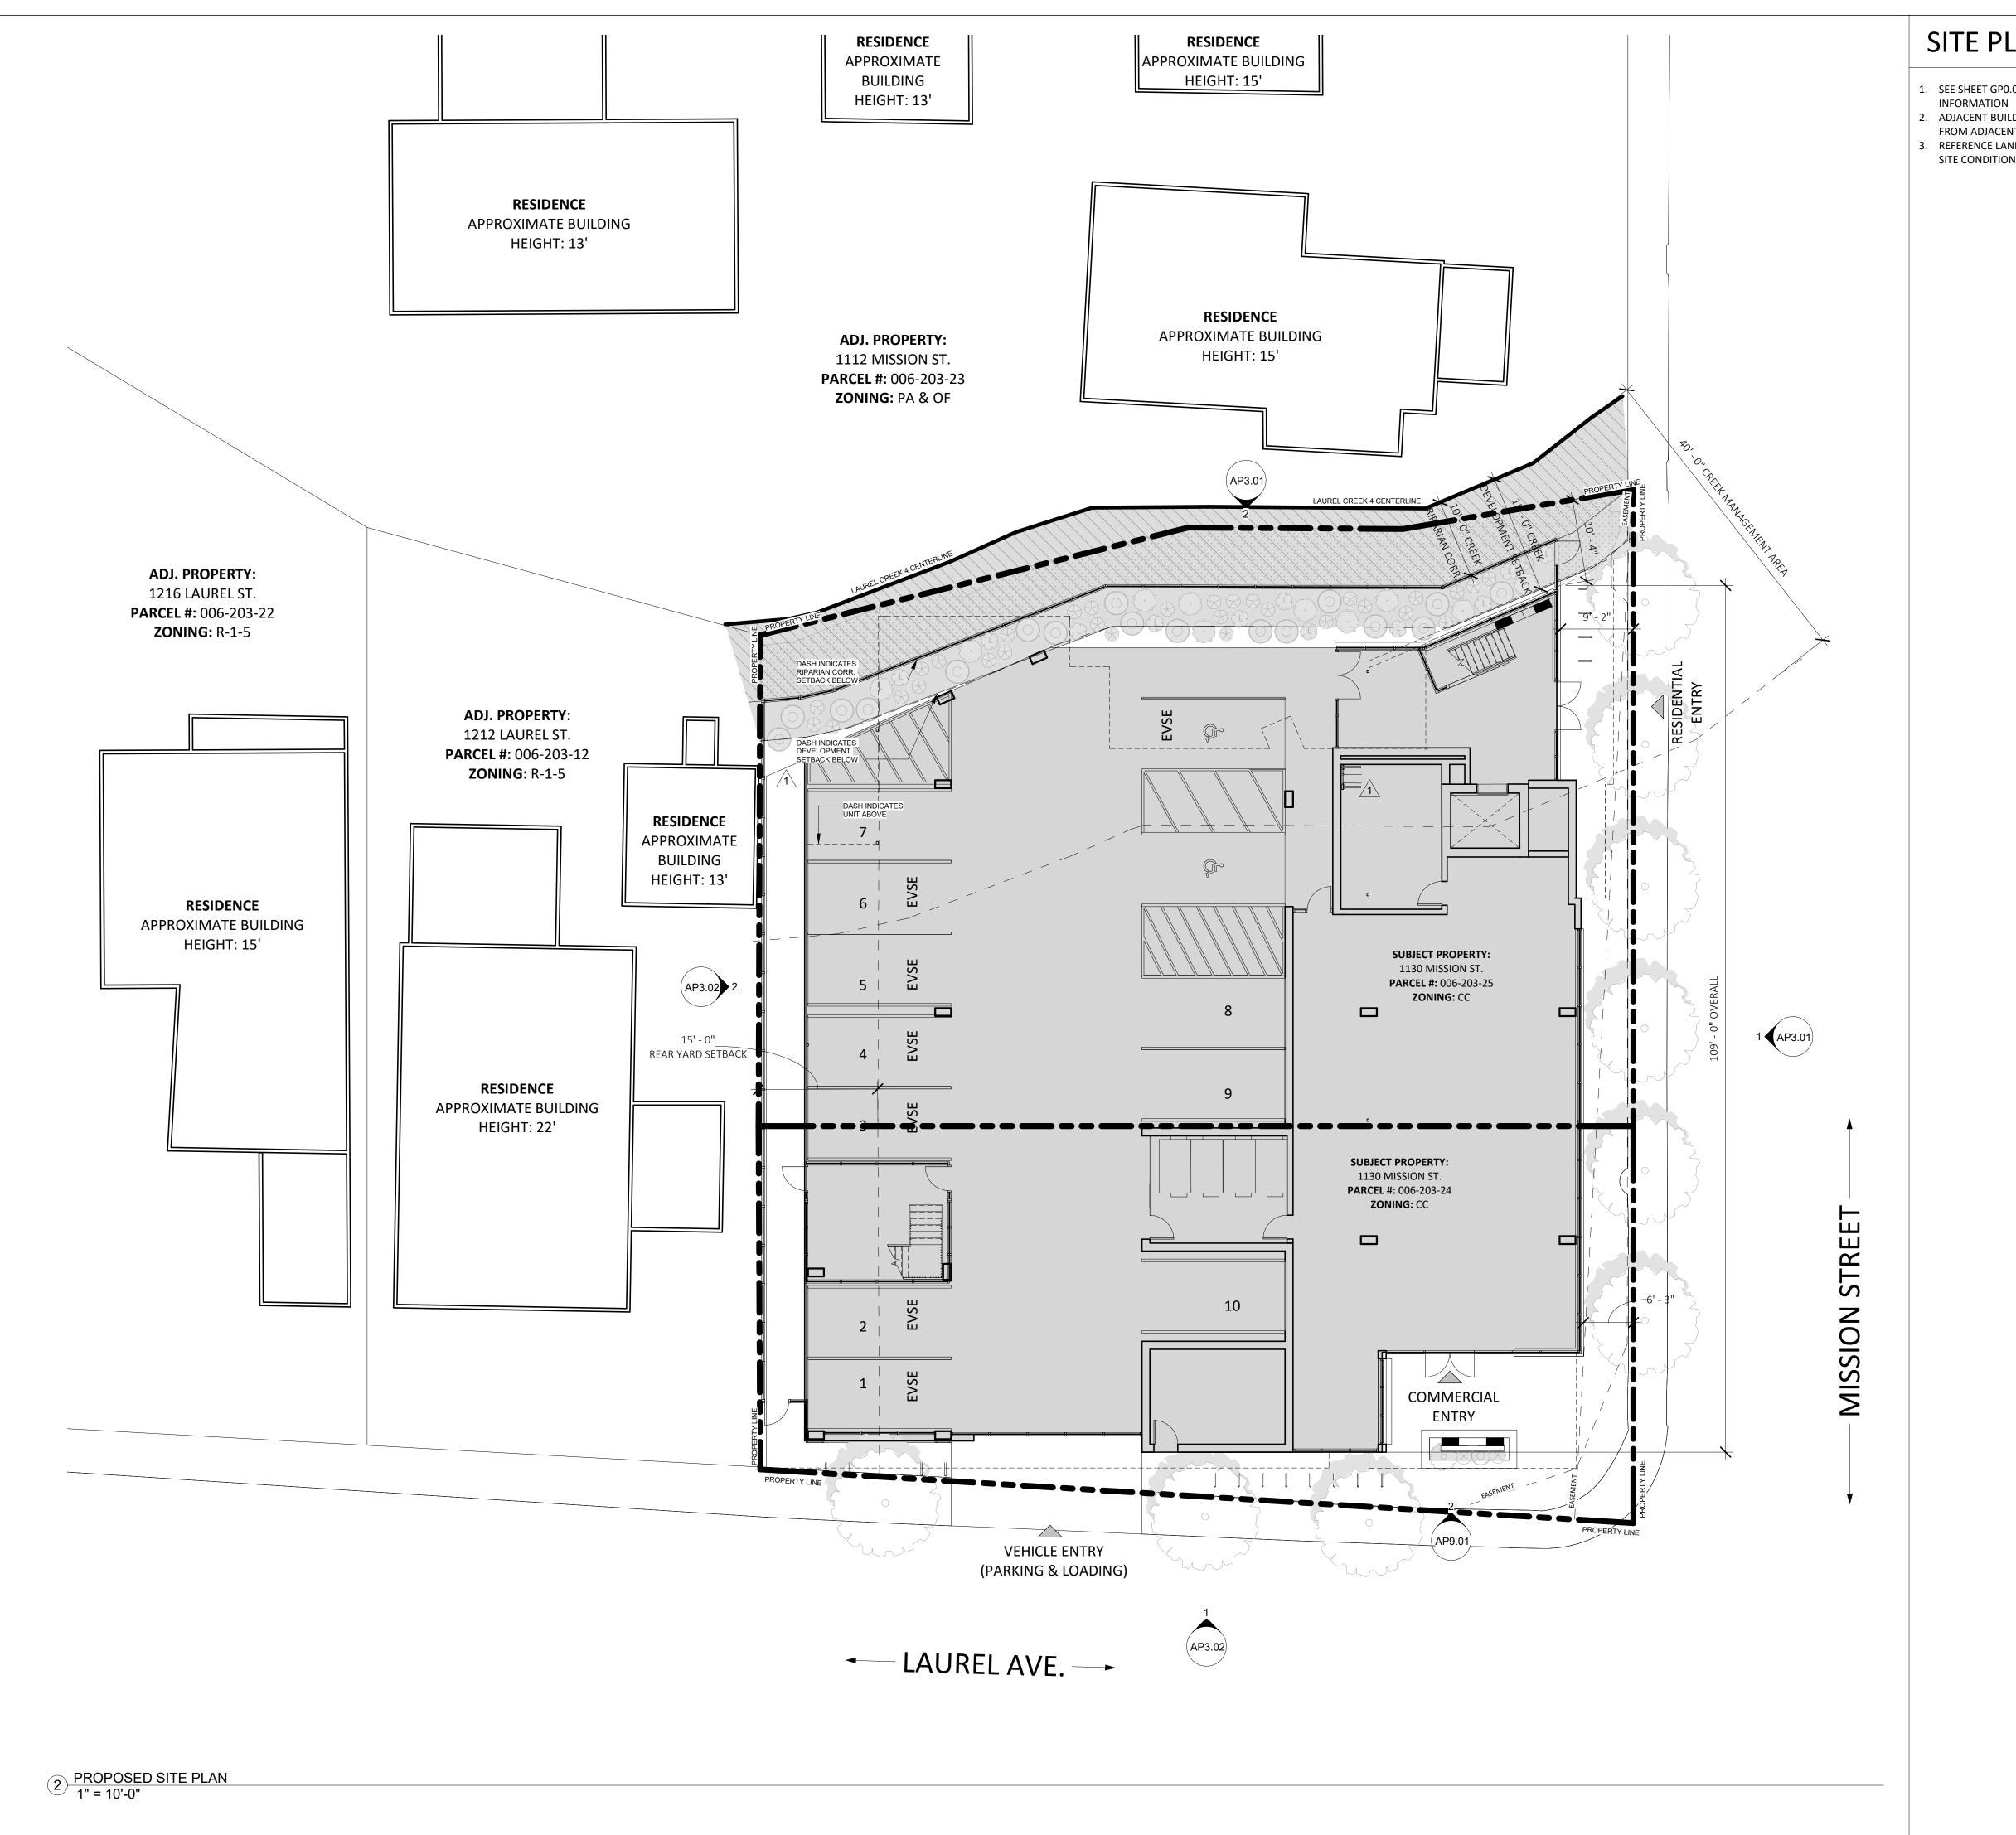

#### SITE PLAN NOTES

- 1. SEE SHEET GP0.01-GP0.05 FOR GENERAL NOTES AND PROJECT
- 2. ADJACENT BUILDING HEIGHTS ARE APPROXIMATE AND ARE TAKEN
- FROM ADJACENT GRADE ELEVATIONS.
- 3. REFERENCE LAND SURVEY FOR SITE ELEVATIONS, SLOPES AND EXISTING SITE CONDITIONS.



189 WALNUT AVENUE SANTA CRUZ, CA 95060 WORKBENCHBUILT.COM P: 831.227.2217

## MISSION 7 $\mathcal{C}$ 8 113

MISION ST. , CA 95060

1130 SANT



Issue	DESCRIPTION	DATE
	SB330 PRE-APPLICATION	01.09.202
0	PLANNING APPLICATION	06.01.202
1	PLANNING REV-01	08.25.202
2	PLANNING REV-02	01.04.202
3	PLANNING REV-03	03.11.202
APN	I number 00	06-203-25
Proj	ect number	21128
Prin	t Date 0	1.09.2023
Dra	wn by	ОН
Che	cked by	EB
Scal	e As	indicated
unpubli	rings and written material appearing herin co shed work of Workbench, Inc. and may not be d without written consent of the Workbench	e duplicated, used o

PROPOSED SITE PLAN

TRUE PROJECT

NORTH NORTH

AP0.51

#### FLOOR PLAN NOTES

- L. SEE SHEET GP0.01-GP0.05 FOR GENERAL NOTES AND PROJECT INFORMATION. 2. ALL UNITS SHALL BE ADAPTABLE PER CBC CH 11A WITH BATHROOMS PER OPTION 2 -U.O.N
- 3. SEE CIVIL DRAWINGS FOR ALL SITE ELEVATIONS, SLOPE AND CURB INFORMATION. 4. SEE LANDSCAPE DRAWINGS FOR PLANTING AND STREET TREE INFORMATION.

#### **UNIT MIX**

UI	NIT TYPE	COUNT	NOTE:
	UNIT A	30	SEE GP0.09 AND GP0.10 FOR GROSS BUILDING AREA
	UNIT B	18	EXHIBITS AND AVERAGE NET
		48	
			UNIT AREA EXHIBITS
AFFO	OCC DRDABLE	UNIT MIX:	PLAN SYMBOL DESIGNATION:
	ORDABLE RY LOW I	UNIT MIX:	
8 VE		UNIT MIX: NCOME	PLAN SYMBOL DESIGNATION:

#### FLOOR PLAN KEYED NOTES

	FLOOR PLAN KEYED NOTES
KEYNOTE	MATERIAL
1	ALIGN
2	CLASS I BICYCLE PARKING
3	CLASS II BICYCLE PARKING
4	PROPOSED NEW PATTERNED METAL FENCE / GATE / SCREEN OR SIM.
5	ABOVE GRADE BUILT-IN PLANTER
6	DASH INDICATES FOOTPRINT OF BUILDING / CANOPY OVERHEAD
7	SLIDING VEHICLE ENTRY GATE
8	MAILBOXES
9	PLANTER / PLANTER BENCH
10	WASHER / DRYER MACHINES PER SRO REQUIREMENTS, 1 PER 20 UNITS
11	RESIDENT STORAGE LOCKERS PER SRO REQUIREMENTS
12	STRUCTURAL COLUMN / ELEMENT
13	SOLAR PHOTOVOLTAIC PANELS
14	MECHANICAL EQUIPMENT AND ROOF SCREEN, LOCATION INDICATED CONCEPTUALLY
15	HATCH INDICATES EXTENT OF VEGETATED ROOF, TRAY SYSTEM OR SIM.

#### RESIDENT AMENITIES


16 EXTERIOR CORRIDOR

TOTAL RESIDENTIAL STORAGE SPACES PROVIDED:	60 SPACES
0 - SINGLE STORAGE LOCKERS	0 SPACES
0 - DOUBLE STORAGE LOCKERS	0 SPACES
20 - TRIPLE STORAGE LOCKERS	60 SPACES 1
TOTAL RESIDENTIAL WASHER/DRYERS PROVIDED:	6 WASHERS, 6 DRYERS
1 WASHER / DRYER REQUIRED PER 20 UNITS:	3 WASHERS, 3 DRYERS

**TOTAL COMMON INDOOR SPACE PROVIDED:** SEE GP0.04 FOR TOTAL COMMON INDOOR SPACE

17 DOWNSPOUTS DRAIN TO STORMWATER PLANTER, REF CIVIL

TOTAL COMMON OUTDOOR SPACE PROVIDED: SEE GP0.04 FOR TOTAL COMMON OUTDOOR SPACE

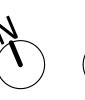

TRUE PROJECT NORTH NORTH



189 WALNUT AVENUE SANTA CRUZ, CA 95060 WORKBENCHBUILT.COM

## P: 831.227.2217

## MISSION 7 $\mathcal{C}$ $\vdash$ Ø

11

MISION ST. , CA 95060

1132 CRUZ,

1130 SANT



Issue	DESCRIPTION	DATE
	SB330 PRE-APPLICA	TION 01.09.202
0	PLANNING APPLICA	TION 06.01.202
1	PLANNING REV-0	08.25.202
2	PLANNING REV-0	01.04.202
3	PLANNING REV-0	03.11.202
APN	number	006-203-25
Proje	ect number	21128
Print	. Date	01.09.2023
Drav	vn by	ОН
Che	cked by	EB
Scale	2	As indicated

PROPOSED FLOOR PLAN - LEVEL 1

AP1.01

#### FLOOR PLAN NOTES

- 1. SEE SHEET GP0.01-GP0.05 FOR GENERAL NOTES AND PROJECT INFORMATION.
- 2. ALL UNITS SHALL BE ADAPTABLE PER CBC CH 11A WITH BATHROOMS PER OPTION 2 -U.O.N
- SEE CIVIL DRAWINGS FOR ALL SITE ELEVATIONS, SLOPE AND CURB INFORMATION.
   SEE LANDSCAPE DRAWINGS FOR PLANTING AND STREET TREE INFORMATION.

#### **UNIT MIX**

	UNIT TYPE	COUNT	NOTE:
	UNIT A	30	SEE GP0.09 AND GP0.10 FOR
	UNIT B	18	GROSS BUILDING AREA
		48	EXHIBITS AND AVERAGE NET
کبر			UNIT AREA EXHIBITS
<i>ب</i> ر ا	VEEORDARI E	LINIT MIY:	PLAN SYMBOL DESIGNATION:
_	AFFORDABLE		PLAN SYMBOL DESIGNATION:
_	AFFORDABLE B VERY LOW I		
8		NCOME —	PLAN SYMBOL DESIGNATION:

#### FLOOR PLAN KEYED NOTES

	FLOOR PLAN KEYED NOTES
KEYNOTE	MATERIAL
1	ALIGN
2	CLASS I BICYCLE PARKING
3	CLASS II BICYCLE PARKING
4	PROPOSED NEW PATTERNED METAL FENCE / GATE / SCREEN OR SIM.
5	ABOVE GRADE BUILT-IN PLANTER
6	DASH INDICATES FOOTPRINT OF BUILDING / CANOPY OVERHEAD
7	SLIDING VEHICLE ENTRY GATE
8	MAILBOXES
9	PLANTER / PLANTER BENCH
10	WASHER / DRYER MACHINES PER SRO REQUIREMENTS, 1 PER 20 UNITS
11	RESIDENT STORAGE LOCKERS PER SRO REQUIREMENTS
12	STRUCTURAL COLUMN / ELEMENT
13	SOLAR PHOTOVOLTAIC PANELS
14	MECHANICAL EQUIPMENT AND ROOF SCREEN, LOCATION INDICATED CONCEPTUALLY
15	HATCH INDICATES EXTENT OF VEGETATED ROOF, TRAY SYSTEM OR SIM.

#### RESIDENT AMENITIES

16 EXTERIOR CORRIDOR

TOTAL RESIDENTIAL STORAGE SPACES PROVIDED: 60 SPACES
0 - SINGLE STORAGE LOCKERS 0 SPACES


0 - DOUBLE STORAGE LOCKERS
0 - DOUBLE STORAGE LOCKERS
20 - TRIPLE STORAGE LOCKERS
60 SPACES

**TOTAL RESIDENTIAL WASHER/DRYERS PROVIDED: 6 WASHERS, 6 DRYERS** 1 WASHER / DRYER REQUIRED PER 20 UNITS: 3 WASHERS, 3 DRYERS

TOTAL COMMON INDOOR SPACE PROVIDED: SEE GP0.04 FOR TOTAL COMMON INDOOR SPACE

17 DOWNSPOUTS DRAIN TO STORMWATER PLANTER, REF CIVIL

TOTAL COMMON OUTDOOR SPACE PROVIDED: SEE GP0.04 FOR TOTAL COMMON OUTDOOR SPACE

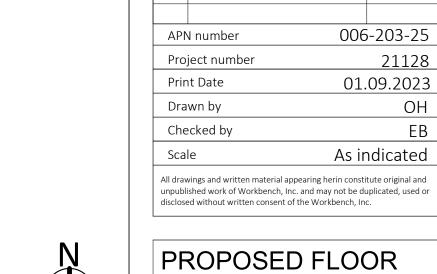

TRUE PROJECT PLAN - LEVEL 2

NORTH NORTH

AP1.02

ISSUES/ REVISIONS

workbench

189 WALNUT AVENUE SANTA CRUZ, CA 95060

P: 831.227.2217

MISSION

7

 $\mathcal{C}$ 

 $\Box$ 

Ø

 $\vdash$ 

 $\vdash$ 

MISION ST. , CA 95060

1130 SANT

WORKBENCHBUILT.COM

4 0.13.04 FIVI

1 SECOND FLOOR PLAN 1/8" = 1'-0"

71' - 8"

1 PROPOSED FLOOR PLAN - LEVEL 3 1/8" = 1'-0"

#### FLOOR PLAN NOTES

- 1. SEE SHEET GP0.01-GP0.05 FOR GENERAL NOTES AND PROJECT INFORMATION.
- 2. ALL UNITS SHALL BE ADAPTABLE PER CBC CH 11A WITH BATHROOMS PER OPTION 2 -U.O.N
- 3. SEE CIVIL DRAWINGS FOR ALL SITE ELEVATIONS, SLOPE AND CURB INFORMATION. 4. SEE LANDSCAPE DRAWINGS FOR PLANTING AND STREET TREE INFORMATION.

#### **UNIT MIX**

	<u></u>	~~~~	
	UNIT TYPE	COUNT	NOTE:
	UNIT A	30	SEE GP0.09 AND GP0.10 FOR
>	UNIT B	18	GROSS BUILDING AREA
\ \		48	EXHIBITS AND AVERAGE NET UNIT AREA EXHIBITS
	AFFORDABLE	UNIT MIX:	PLAN SYMBOL DESIGNATION:
_	3 VERY LOW II		
	50 MARKET RA		
	1 MANAGER U		M

#### FLOOR PLAN KEYED NOTES

	FLOOR PLAN KEYED NOTES
KEYNOTE	MATERIAL
1	ALIGN
2	CLASS I BICYCLE PARKING
3	CLASS II BICYCLE PARKING
4	PROPOSED NEW PATTERNED METAL FENCE / GATE / SCREEN OR SIM.
5	ABOVE GRADE BUILT-IN PLANTER
6	DASH INDICATES FOOTPRINT OF BUILDING / CANOPY OVERHEAD
7	SLIDING VEHICLE ENTRY GATE
8	MAILBOXES
9	PLANTER / PLANTER BENCH
10	WASHER / DRYER MACHINES PER SRO REQUIREMENTS, 1 PER 20 UNITS
11	RESIDENT STORAGE LOCKERS PER SRO REQUIREMENTS
12	STRUCTURAL COLUMN / ELEMENT
13	SOLAR PHOTOVOLTAIC PANELS
14	MECHANICAL EQUIPMENT AND ROOF SCREEN, LOCATION INDICATED CONCEPTUALLY
15	HATCH INDICATES EXTENT OF VEGETATED ROOF, TRAY SYSTEM OR SIM.
	<u> </u>

#### RESIDENT AMENITIES


16 EXTERIOR CORRIDOR

FOTAL RESIDENTIAL STORAGE SPACES PROVIDED:	60 SPACES
0 - SINGLE STORAGE LOCKERS	0 SPACES
0 - DOUBLE STORAGE LOCKERS	0 SPACES
20 - TRIPLE STORAGE LOCKERS	60 SPACES 1
TOTAL RESIDENTIAL WASHER/DRYERS PROVIDED:	6 WASHERS, 6 DRYERS
1 WASHER / DRYER REQUIRED PER 20 UNITS:	3 WASHERS, 3 DRYERS

**TOTAL COMMON INDOOR SPACE PROVIDED:** SEE GP0.04 FOR TOTAL COMMON INDOOR SPACE

17 DOWNSPOUTS DRAIN TO STORMWATER PLANTER, REF CIVIL

**TOTAL COMMON OUTDOOR SPACE PROVIDED:** SEE GP0.04 FOR TOTAL COMMON OUTDOOR SPACE

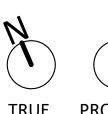

TRUE PROJECT

unpublished work of Workbench, Inc. and may not be duplicated, used or disclosed without written consent of the Workbench, Inc.  $\,$ PROPOSED FLOOR PLAN - LEVEL 3

AP1.03

workbench

SANTA CRUZ, CA 95060 WORKBENCHBUILT.COM P: 831.227.2217

189 WALNUT AVENUE

## MISSION 7 $\mathcal{C}$ $\vdash$ Ø

 $\Box$ 

 $\leftarrow$ 

ISSUES/ REVISIONS

Print Date Drawn by

Checked by

DESCRIPTION

PLANNING APPLICATION PLANNING REV-01

PLANNING REV-02

PLANNING REV-03

SB330 PRE-APPLICATION 01.09.2023

MISION ST. , CA 95060

1132 CRUZ,

1130 SANT

DATE

08.25.2023

01.04.2024

006-203-25

01.09.2023

As indicated

1 PROPOSED FLOOR PLAN - LEVEL 4 1/8" = 1'-0"

#### FLOOR PLAN NOTES

- 1. SEE SHEET GP0.01-GP0.05 FOR GENERAL NOTES AND PROJECT INFORMATION.
- 2. ALL UNITS SHALL BE ADAPTABLE PER CBC CH 11A WITH BATHROOMS PER OPTION 2 -U.O.N
- 3. SEE CIVIL DRAWINGS FOR ALL SITE ELEVATIONS, SLOPE AND CURB INFORMATION. 4. SEE LANDSCAPE DRAWINGS FOR PLANTING AND STREET TREE INFORMATION.

#### **UNIT MIX**

UNIT TYPE	COUNT	NOTE:
UNIT A	30	SEE GP0.09 AND GP0.10 FOR
UNIT B	18	GROSS BUILDING AREA
	48	EXHIBITS AND AVERAGE NET
	M	UNIT AREA EXHIBITS
AEEODDARI E	LINIT MIV	PLAN SYMBOL DESIGNATION:
AFFORDABLE		PLAN SYMBOL DESIGNATION:
AFFORDABLE B VERY LOW I		
_	NCOME —	PLAN SYMBOL DESIGNATION:

#### FLOOR PLAN KEYED NOTES

	FLOOR PLAN KEYED NOTES
KEYNOTE	MATERIAL
1	ALIGN
2	CLASS I BICYCLE PARKING
3	CLASS II BICYCLE PARKING
4	PROPOSED NEW PATTERNED METAL FENCE / GATE / SCREEN OR SIM.
5	ABOVE GRADE BUILT-IN PLANTER
6	DASH INDICATES FOOTPRINT OF BUILDING / CANOPY OVERHEAD
7	SLIDING VEHICLE ENTRY GATE
8	MAILBOXES
9	PLANTER / PLANTER BENCH
10	WASHER / DRYER MACHINES PER SRO REQUIREMENTS, 1 PER 20 UNITS
11	RESIDENT STORAGE LOCKERS PER SRO REQUIREMENTS
12	STRUCTURAL COLUMN / ELEMENT
13	SOLAR PHOTOVOLTAIC PANELS
14	MECHANICAL EQUIPMENT AND ROOF SCREEN, LOCATION INDICATED CONCEPTUALLY
15	HATCH INDICATES EXTENT OF VEGETATED ROOF, TRAY SYSTEMOR SIM.

17 DOWNSPOUTS DRAIN TO STORMWATER PLANTER, REF CIVIL


#### RESIDENT AMENITIES


16 EXTERIOR CORRIDOR

TOTAL RESIDENTIAL STORAGE SPACES PROVIDED: 60 SPACES 0 - SINGLE STORAGE LOCKERS 0 SPACES 0 SPACES 0 - DOUBLE STORAGE LOCKERS 60 SPACES 20 - TRIPLE STORAGE LOCKERS TOTAL RESIDENTIAL WASHER/DRYERS PROVIDED: 6 WASHERS, 6 DRYERS 1 WASHER / DRYER REQUIRED PER 20 UNITS: 3 WASHERS, 3 DRYERS

**TOTAL COMMON INDOOR SPACE PROVIDED:** SEE GP0.04 FOR TOTAL COMMON INDOOR SPACE

**TOTAL COMMON OUTDOOR SPACE PROVIDED:** SEE GP0.04 FOR TOTAL COMMON OUTDOOR SPACE

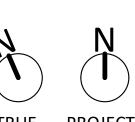

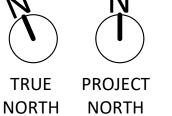

006-203-25 APN number 21128 Project number 01.09.2023 Print Date Drawn by Checked by As indicated unpublished work of Workbench, Inc. and may not be duplicated, used or disclosed without written consent of the Workbench, Inc.

workbench

189 WALNUT AVENUE SANTA CRUZ, CA 95060

P: 831.227.2217

MISSION

7

 $\mathcal{C}$ 

 $\vdash$ 

Ø

 $\Box$ 

 $\vdash$ 

ISSUES/ REVISIONS

DESCRIPTION

PLANNING APPLICATION

PLANNING REV-01

PLANNING REV-02

PLANNING REV-03

SB330 PRE-APPLICATION 01.09.2023

MISION ST. , CA 95060

1132 CRUZ,

1130 SANT

DATE

08.25.2023

01.04.2024

03.11.2024

WORKBENCHBUILT.COM

PROPOSED FLOOR PLAN - LEVEL 4

AP1.04

#### FLOOR PLAN NOTES

- 1. SEE SHEET GP0.01-GP0.05 FOR GENERAL NOTES AND PROJECT INFORMATION.
- 2. ALL UNITS SHALL BE ADAPTABLE PER CBC CH 11A WITH BATHROOMS PER OPTION 2 -U.O.N
- 3. SEE CIVIL DRAWINGS FOR ALL SITE ELEVATIONS, SLOPE AND CURB INFORMATION. 4. SEE LANDSCAPE DRAWINGS FOR PLANTING AND STREET TREE INFORMATION.

#### **UNIT MIX**

UNIT TYPE	COUNT	NOTE:
UNIT A	30	SEE GP0.09 AND GP0.10 FOR
UNIT B	18	GROSS BUILDING AREA
	48	EXHIBITS AND AVERAGE NET UNIT AREA EXHIBITS
	M	
AFFORDABLE	UNIT MIX:	PLAN SYMBOL DESIGNATION:
AFFORDABLE B VERY LOW I		PLAN SYMBOL DESIGNATION:  A
	NCOME —	

#### FLOOR PLAN KEYED NOTES

	FLOOR PLAN KEYED NOTES
KEYNOTE	MATERIAL
1	ALIGN
2	CLASS I BICYCLE PARKING
3	CLASS II BICYCLE PARKING
4	PROPOSED NEW PATTERNED METAL FENCE / GATE / SCREEN OR SIM.
5	ABOVE GRADE BUILT-IN PLANTER
6	DASH INDICATES FOOTPRINT OF BUILDING / CANOPY OVERHEAD
7	SLIDING VEHICLE ENTRY GATE
8	MAILBOXES
9	PLANTER / PLANTER BENCH
10	WASHER / DRYER MACHINES PER SRO REQUIREMENTS, 1 PER 20 UNITS
11	RESIDENT STORAGE LOCKERS PER SRO REQUIREMENTS
12	STRUCTURAL COLUMN / ELEMENT
13	SOLAR PHOTOVOLTAIC PANELS
14	MECHANICAL EQUIPMENT AND ROOF SCREEN, LOCATION INDICATED CONCEPTUALLY
15	HATCH INDICATES EXTENT OF VEGETATED ROOF, TRAY SYSTEMOR SIM.


17 DOWNSPOUTS DRAIN TO STORMWATER PLANTER, REF CIVIL

**TOTAL COMMON OUTDOOR SPACE PROVIDED:** SEE GP0.04 FOR TOTAL COMMON OUTDOOR SPACE

#### RESIDENT AMENITIES

16 EXTERIOR CORRIDOR

TOTAL RESIDENTIAL STORAGE SPACES PROVIDED:	60 SPACES
0 - SINGLE STORAGE LOCKERS	0 SPACES
0 - DOUBLE STORAGE LOCKERS	0 SPACES
20 - TRIPLE STORAGE LOCKERS	60 SPACES 1
OTAL RESIDENTIAL WASHER/DRYERS PROVIDED:	6 WASHERS, 6 DRYERS
1 WASHER / DRYER REQUIRED PER 20 UNITS:	3 WASHERS, 3 DRYERS

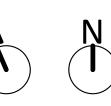

TRUE PROJECT NORTH NORTH

ISSUES/ REVISIONS DESCRIPTION DATE SB330 PRE-APPLICATION 01.09.2023 PLANNING APPLICATION PLANNING REV-01 08.25.2023 PLANNING REV-02 01.04.2024 PLANNING REV-03 006-203-25 01.09.2023 Print Date Drawn by Checked by As indicated

PROPOSED FLOOR PLAN - LEVEL 5

unpublished work of Workbench, Inc. and may not be duplicated, used or disclosed without written consent of the Workbench, Inc.

AP1.05

workbench

189 WALNUT AVENUE SANTA CRUZ, CA 95060 WORKBENCHBUILT.COM

P: 831.227.2217

MISSION 7  $\mathcal{C}$  $\vdash$ Ø

 $\leftarrow$ 

MISION ST. , CA 95060

1132 CRUZ,

1130 SANT

#### FLOOR PLAN NOTES

- SEE SHEET GP0.01-GP0.05 FOR GENERAL NOTES AND PROJECT INFORMATION.
- ALL UNITS SHALL BE ADAPTABLE PER CBC CH 11A WITH BATHROOMS PER OPTION 2 -U.O.N
- 3. SEE CIVIL DRAWINGS FOR ALL SITE ELEVATIONS, SLOPE AND CURB INFORMATION. 4. SEE LANDSCAPE DRAWINGS FOR PLANTING AND STREET TREE INFORMATION.
- **UNIT MIX**

	UNIT TYPE	COUNT	NOTE:
	UNIT A	30	SEE GP0.09 AND GP0.10 FOR
	UNIT B	18	GROSS BUILDING AREA
		48	EXHIBITS AND AVERAGE NET
ノ			
<u>ب</u>	AFFORDARI F	UNIT MIX:	PLAN SYMBOL DESIGNATION:
_	AFFORDABLE IS VERY LOW IN		PLAN SYMBOL DESIGNATION:  A
8	AFFORDABLE IS VERY LOW IN	NCOME —	

FLOOR PLAN KEYED NOTES

#### FLOOR PLAN KEYED NOTES

KEYNOTE	MATERIAL
1	ALIGN
2	CLASS I BICYCLE PARKING
3	CLASS II BICYCLE PARKING
4	PROPOSED NEW PATTERNED METAL FENCE / GATE / SCREEN OR SIM.
5	ABOVE GRADE BUILT-IN PLANTER
6	DASH INDICATES FOOTPRINT OF BUILDING / CANOPY OVERHEAD
7	SLIDING VEHICLE ENTRY GATE
8	MAILBOXES
9	PLANTER / PLANTER BENCH
10	WASHER / DRYER MACHINES PER SRO REQUIREMENTS, 1 PER 20 UNITS
11	RESIDENT STORAGE LOCKERS PER SRO REQUIREMENTS
12	STRUCTURAL COLUMN / ELEMENT
13	SOLAR PHOTOVOLTAIC PANELS
14	MECHANICAL EQUIPMENT AND ROOF SCREEN, LOCATION INDICATED CONCEPTUALLY
15	HATCH INDICATES EXTENT OF VEGETATED ROOF, TRAY SYSTEM OR SIM.

17 DOWNSPOUTS DRAIN TO STORMWATER PLANTER, REF CIVIL

#### RESIDENT AMENITIES

16 EXTERIOR CORRIDOR

TOTAL RESIDENTIAL STORAGE SPACES PROVIDED: 60 SPACES 0 - SINGLE STORAGE LOCKERS 0 - DOUBLE STORAGE LOCKERS


20 - TRIPLE STORAGE LOCKERS

0 SPACES 0 SPACES 60 SPACES

TOTAL RESIDENTIAL WASHER/DRYERS PROVIDED: 6 WASHERS, 6 DRYERS 1 WASHER / DRYER REQUIRED PER 20 UNITS: 3 WASHERS, 3 DRYERS

**TOTAL COMMON INDOOR SPACE PROVIDED:** SEE GP0.04 FOR TOTAL COMMON INDOOR SPACE

**TOTAL COMMON OUTDOOR SPACE PROVIDED:** SEE GP0.04 FOR TOTAL COMMON OUTDOOR SPACE

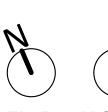

TRUE PROJECT NORTH NORTH

PLANNING APPLICATION 08.25.2023 PLANNING REV-01 PLANNING REV-02 01.04.2024 PLANNING REV-03 006-203-25 01.09.2023 Print Date Drawn by Checked by As indicated unpublished work of Workbench, Inc. and may not be duplicated, used or disclosed without written consent of the Workbench, Inc.

workbench

189 WALNUT AVENUE SANTA CRUZ, CA 95060 WORKBENCHBUILT.COM

P: 831.227.2217

MISSION

32

 $\vdash$ 

 $\infty$ 

11

ISSUES/ REVISIONS

DESCRIPTION

SB330 PRE-APPLICATION 01.09.2023

DATE

MISION ST. , CA 95060

PROPOSED ROOF PLAN

AP1.06




#### **ELEVATIONS GENERAL NOTES**

- PROPERTY LINES ARE SHOWN RELATIVE TO THE ELEVATION, REFER TO PLAN DRAWINGS FOR
- CURBS AND STREETS ARE SHOWN RELATIVE TO THE ELEVATION VIEW, REFER TO LAND SURVEY FOR EXISTING CURB, GUTTER, AND STREET INFORMATION.

#### **ELEVATION KEYED NOTES**


	ELEVATION KEYED NOTES
KEYNOTE	MATERIAL
1	ALIGN
2	TEXTURED CONCRETE, BOARD FORMED OR SIM.
3	METAL PANEL, CORTEN FINISH OR SIM.
4	GLAZED ALUMINUM WINDOW SYSTEM OR SIM.
5	BUILT-IN PLANTER, FINISH TO MATCH TEXTURED CONCRETE OR SIM.
6	RAINSCREEN CLAD STRUCTURAL MEMBERS
7	PATTERNED METAL FENCE / GATE / SCREEN OR SIM.
8	WHITE FIBER CEMENT PANEL OR STUCCO OR SIM.
9	ALUMINUM OR VINYL WINDOW
10	METAL GUARDRAIL OR HANDRAIL
11	TEXTURED FIBER CEMENT PANE OR SIM.
12	GREY FIBER CEMENT PANEL OR STUCCO OR SIM.
13	METAL SUNSHADE
14	TEXTURED CONCRETE LOOK FIBER CEMENT PANEL OR SIM.
15	WARM BRONZE TONED METAL PANEL OR SIM.
16	DARK BRONZE METAL PANEL / SPANDREL PANEL OR SIM.
17	BUILDING SIGNAGE, FINAL LOCATION / DESIGN TBD
18	EXTERIOR WALKWAY AND SUPPORT STRUCTURE
19	STRUCTURAL COLUMN, CONCRETE FINISH OR SIM.
20	PAINTED MURAL ON BUILDING FINISH, FINAL ARTWORK / ARTIST TBD
21	DOWNSPOUTS ROUTE TO FLOW-THROUGH PLANTER, REF CIVIL


#### **MATERIALS LEGEND**

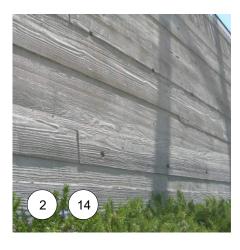






8

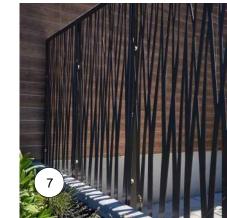


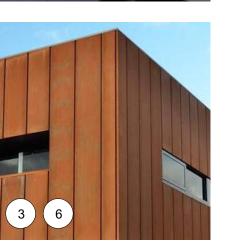

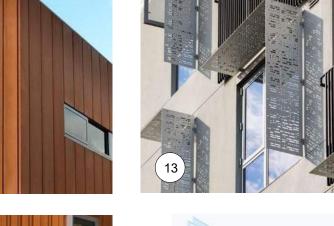

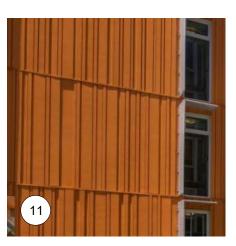

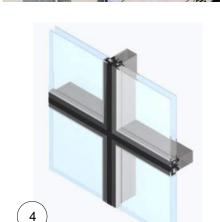

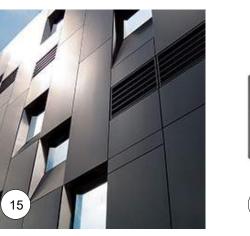





189 WALNUT AVENUE SANTA CRUZ, CA 95060 WORKBENCHBUILT.COM

P: 831.227.2217

## MISSION 7 $\mathcal{C}$ $\infty$

113

MISION ST. , CA 95060

1132 CRUZ,

1130 SANT

Issue	DESCRIPTION	DATE
	SB330 PRE-APPLICATION	01.09.202
0	PLANNING APPLICATION	06.01.202
1	PLANNING REV-01	08.25.202
2	PLANNING REV-02	01.04.20
3	PLANNING REV-03	03.11.202
APN	number 00	06-203-25
Proj	ect number	21128
Prin	t Date 0	1.09.202
Drav	wn by	OH
Che	cked by	EE
Scal	e As	indicated

PROPOSED ELEVATIONS

AP3.01


#### **ELEVATIONS GENERAL NOTES**

- 2. CURBS AND STREETS ARE SHOWN RELATIVE TO THE ELEVATION VIEW, REFER TO LAND SURVEY FOR EXISTING CURB, GUTTER, AND STREET INFORMATION.

#### **ELEVATION KEYED NOTES**

	ELEVATION KEYED NOTES
KEYNOTE	MATERIAL
1	ALIGN
2	TEXTURED CONCRETE, BOARD FORMED OR SIM.
3	METAL PANEL, CORTEN FINISH OR SIM.
4	GLAZED ALUMINUM WINDOW SYSTEM OR SIM.
5	BUILT-IN PLANTER, FINISH TO MATCH TEXTURED CONCRETE OR
6	SIM.
6	RAINSCREEN CLAD STRUCTURAL MEMBERS
7	PATTERNED METAL FENCE / GATE / SCREEN OR SIM.
8	WHITE FIBER CEMENT PANEL OR STUCCO OR SIM.
9	ALUMINUM OR VINYL WINDOW
10	METAL GUARDRAIL OR HANDRAIL
11	TEXTURED FIBER CEMENT PANE OR SIM.
12	GREY FIBER CEMENT PANEL OR STUCCO OR SIM.
13	METAL SUNSHADE
14	TEXTURED CONCRETE LOOK FIBER CEMENT PANEL OR SIM.
15	WARM BRONZE TONED METAL PANEL OR SIM.
16	DARK BRONZE METAL PANEL / SPANDREL PANEL OR SIM.
17	BUILDING SIGNAGE, FINAL LOCATION / DESIGN TBD
18	EXTERIOR WALKWAY AND SUPPORT STRUCTURE
19	STRUCTURAL COLUMN, CONCRETE FINISH OR SIM.
20	PAINTED MURAL ON BUILDING FINISH, FINAL ARTWORK / ARTIST TBD
21	DOWNSPOUTS ROUTE TO FLOW-THROUGH PLANTER, REF CIVIL


#### **MATERIALS LEGEND**

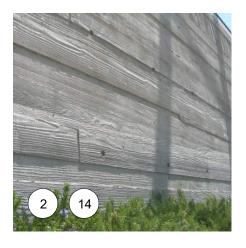






8




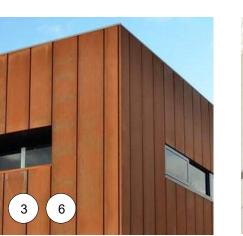

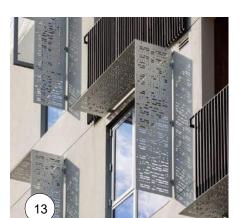

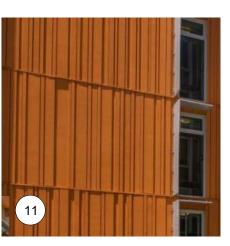

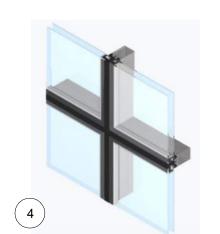

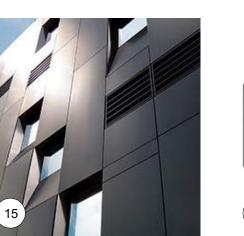





189 WALNUT AVENUE SANTA CRUZ, CA 95060 WORKBENCHBUILT.COM

## P: 831.227.2217

## MISSION 7 $\mathcal{C}$ 1130

MISION ST. ., CA 95060

1132 | CRUZ,


1130 SANT

NOT FOR TION ON STRUCTION

Issue	DESCRIPTION	DATE
	SB330 PRE-APPLICATION	01.09.202
0	PLANNING APPLICATION	06.01.202
1	PLANNING REV-01	08.25.202
2	PLANNING REV-02	01.04.202
3	PLANNING REV-03	03.11.202
APN	I number 00	06-203-25
Proj	ect number	21128
Prin	t Date O	1.09.2023
Dra	wn by	OH
Che	cked by	EB
Scal	e As	indicated

PROPOSED ELEVATIONS

AP3.02

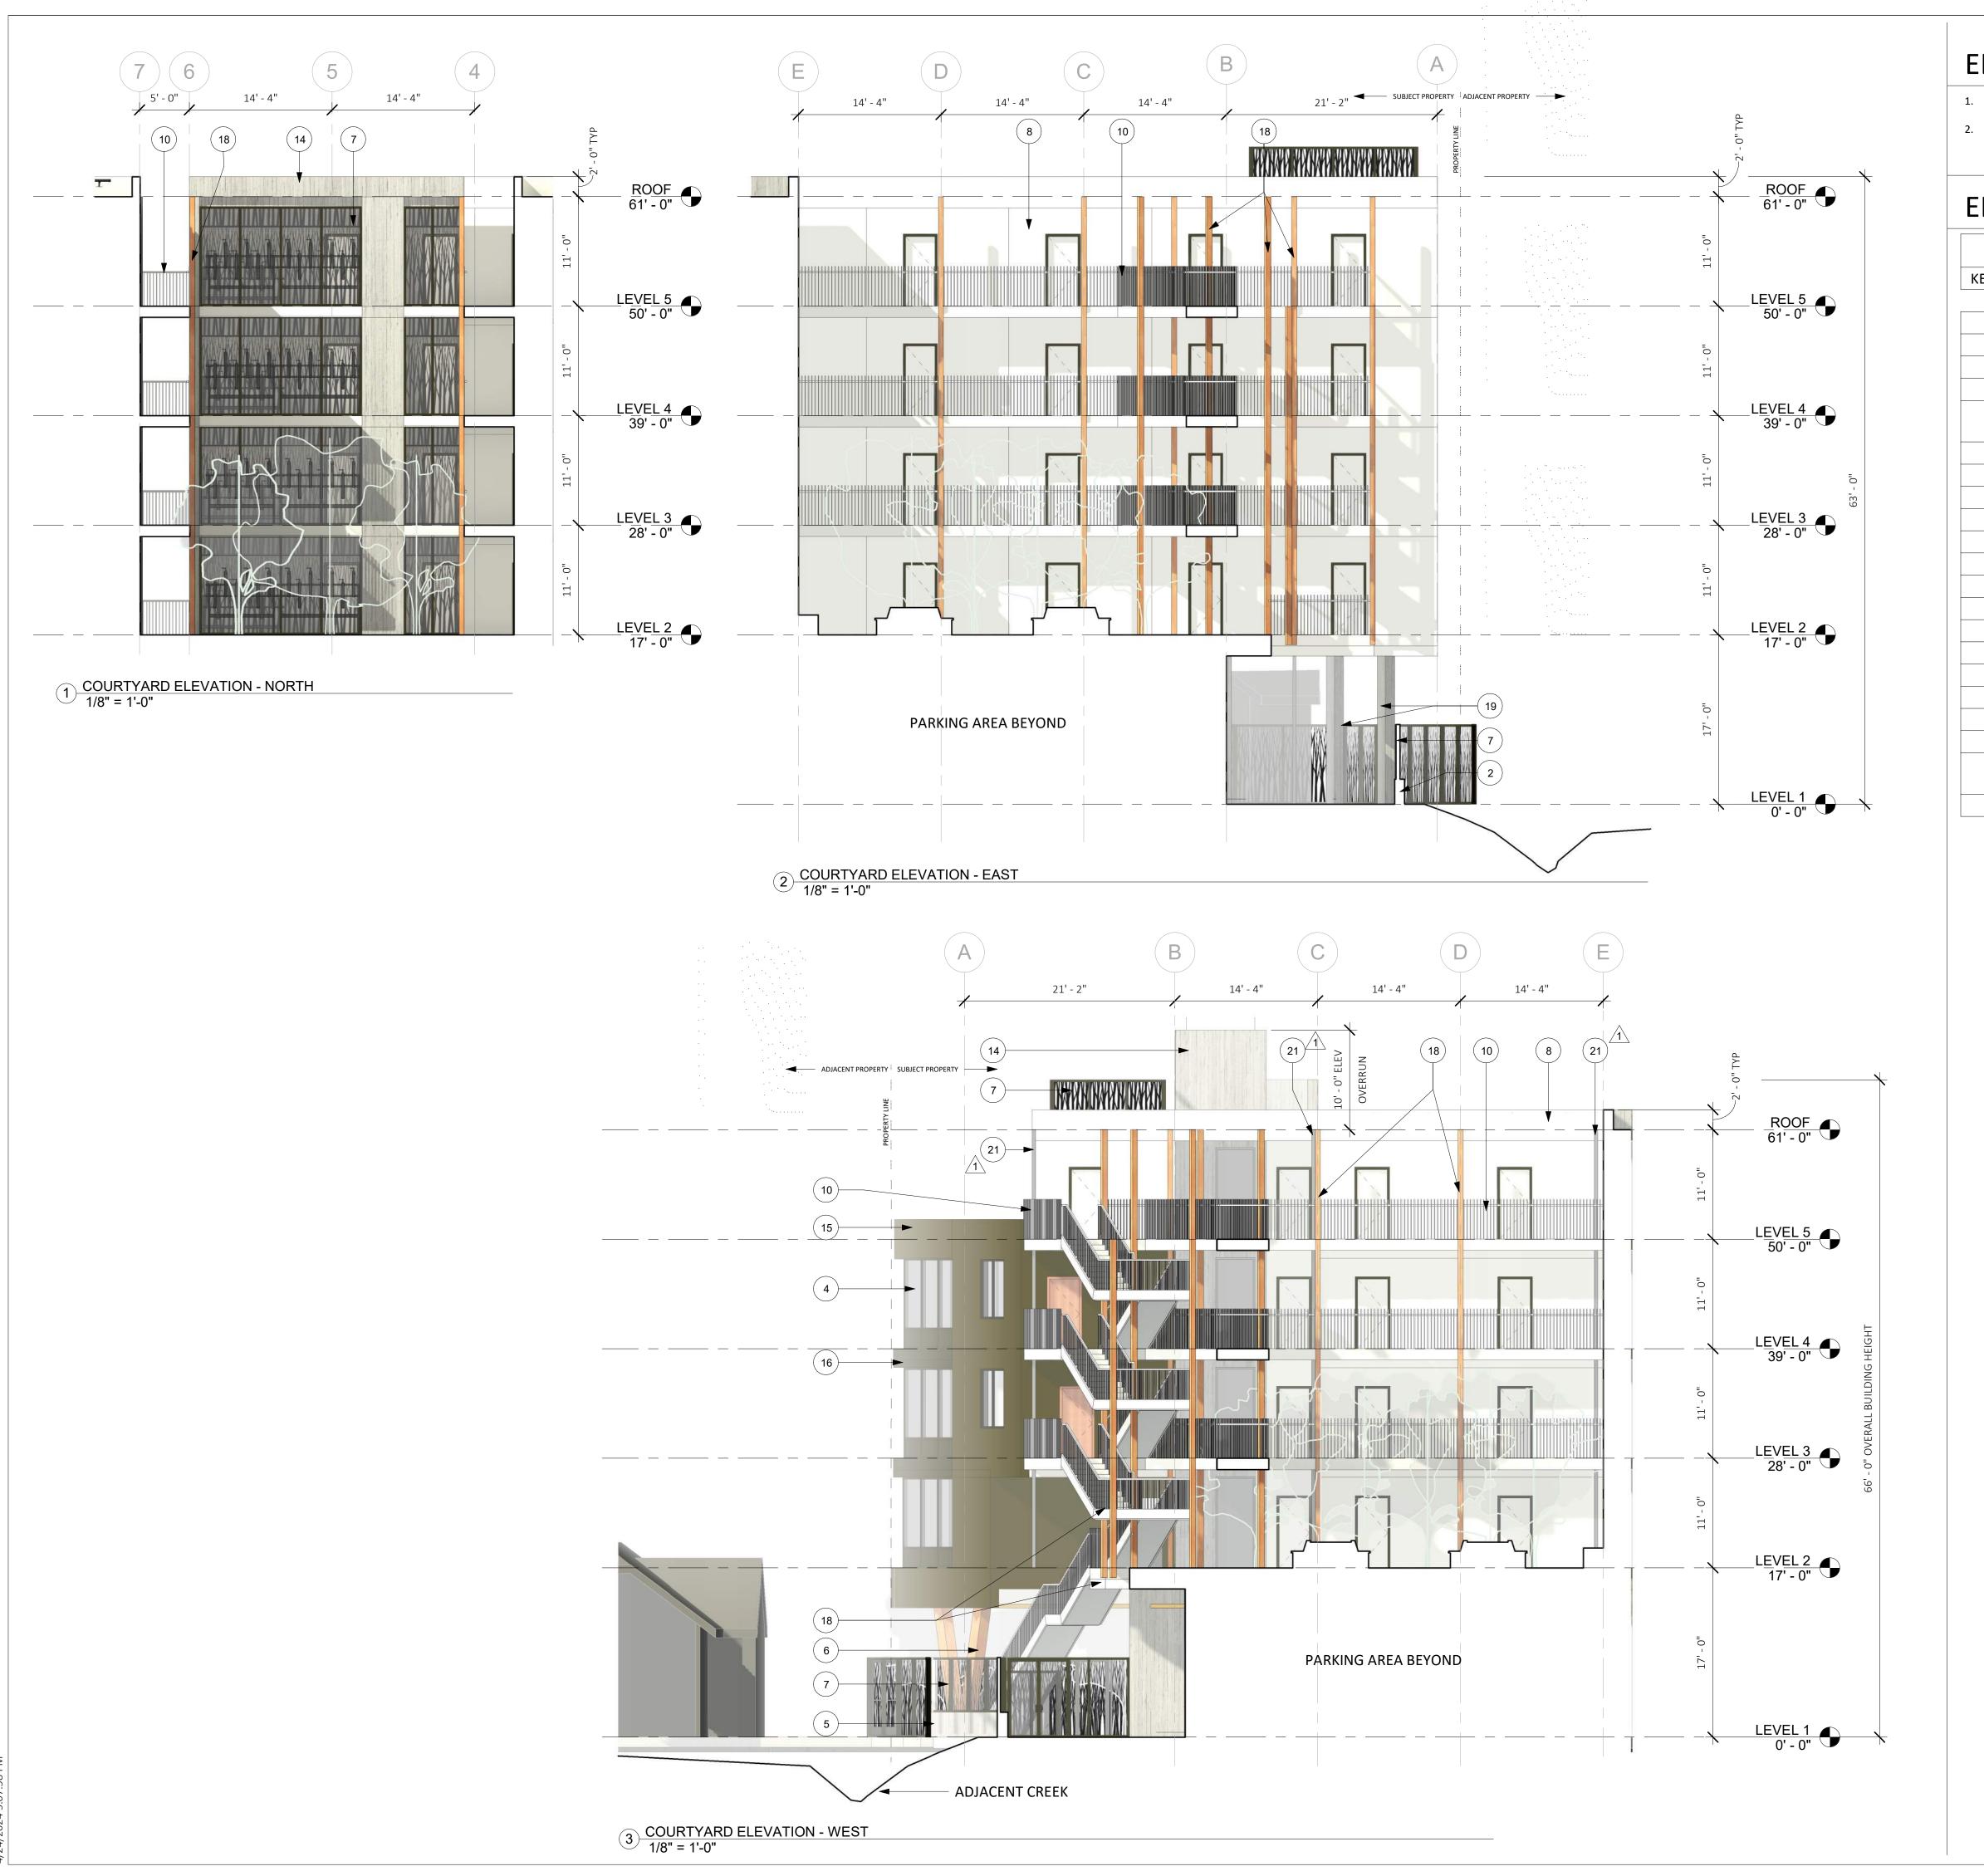

#### **ELEVATIONS GENERAL NOTES**


- 2. CURBS AND STREETS ARE SHOWN RELATIVE TO THE ELEVATION VIEW, REFER TO LAND SURVEY FOR EXISTING CURB, GUTTER, AND STREET INFORMATION.

#### **ELEVATION KEYED NOTES**


	ELEVATION KEYED NOTES
KEYNOTE	MATERIAL
1	ALIGN
2	TEXTURED CONCRETE, BOARD FORMED OR SIM.
3	METAL PANEL, CORTEN FINISH OR SIM.
4	GLAZED ALUMINUM WINDOW SYSTEM OR SIM.
5	BUILT-IN PLANTER, FINISH TO MATCH TEXTURED CONCRETE OF SIM.
6	RAINSCREEN CLAD STRUCTURAL MEMBERS
7	PATTERNED METAL FENCE / GATE / SCREEN OR SIM.
8	WHITE FIBER CEMENT PANEL OR STUCCO OR SIM.
9	ALUMINUM OR VINYL WINDOW
10	METAL GUARDRAIL OR HANDRAIL
11	TEXTURED FIBER CEMENT PANE OR SIM.
12	GREY FIBER CEMENT PANEL OR STUCCO OR SIM.
13	METAL SUNSHADE
14	TEXTURED CONCRETE LOOK FIBER CEMENT PANEL OR SIM.
15	WARM BRONZE TONED METAL PANEL OR SIM.
16	DARK BRONZE METAL PANEL / SPANDREL PANEL OR SIM.
17	BUILDING SIGNAGE, FINAL LOCATION / DESIGN TBD
18	EXTERIOR WALKWAY AND SUPPORT STRUCTURE
19	STRUCTURAL COLUMN, CONCRETE FINISH OR SIM.
20	PAINTED MURAL ON BUILDING FINISH, FINAL ARTWORK / ARTIST TBD
21	DOWNSPOUTS ROUTE TO FLOW-THROUGH PLANTER, REF CIVIL


#### **MATERIALS LEGEND**




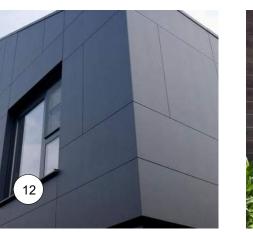



8

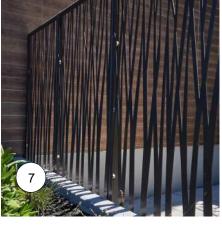

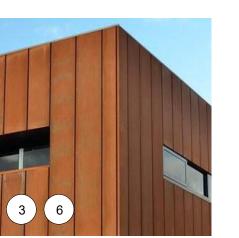

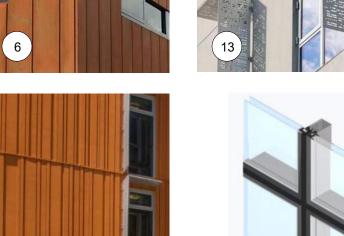

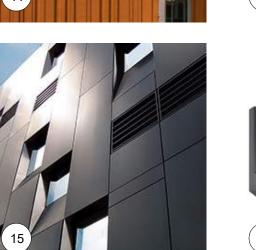

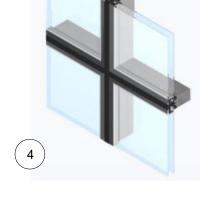





189 WALNUT AVENUE SANTA CRUZ, CA 95060 WORKBENCHBUILT.COM

P: 831.227.2217

## MISSION 32 $\vdash$ $\infty$

11

MISION ST. , CA 95060


1132 I CRUZ,

1130 SANT

Issue	DESCRIPTION	J	DATE
	SB330 PRE-APPLIC	ATION	01.09.202
0	PLANNING APPLICA	ATION	06.01.202
1	PLANNING REV	-01	08.25.202
2	PLANNING REV	-02	01.04.202
3	PLANNING REV	-03	03.11.202
APN	I number	006	
Proj	ect number		21128
Prin	t Date	01	.09.2023
Dra	wn by		ОН
Che	cked by		EB
Scal	е	As in	ndicated

PROPOSED ELEVATIONS

AP3.03

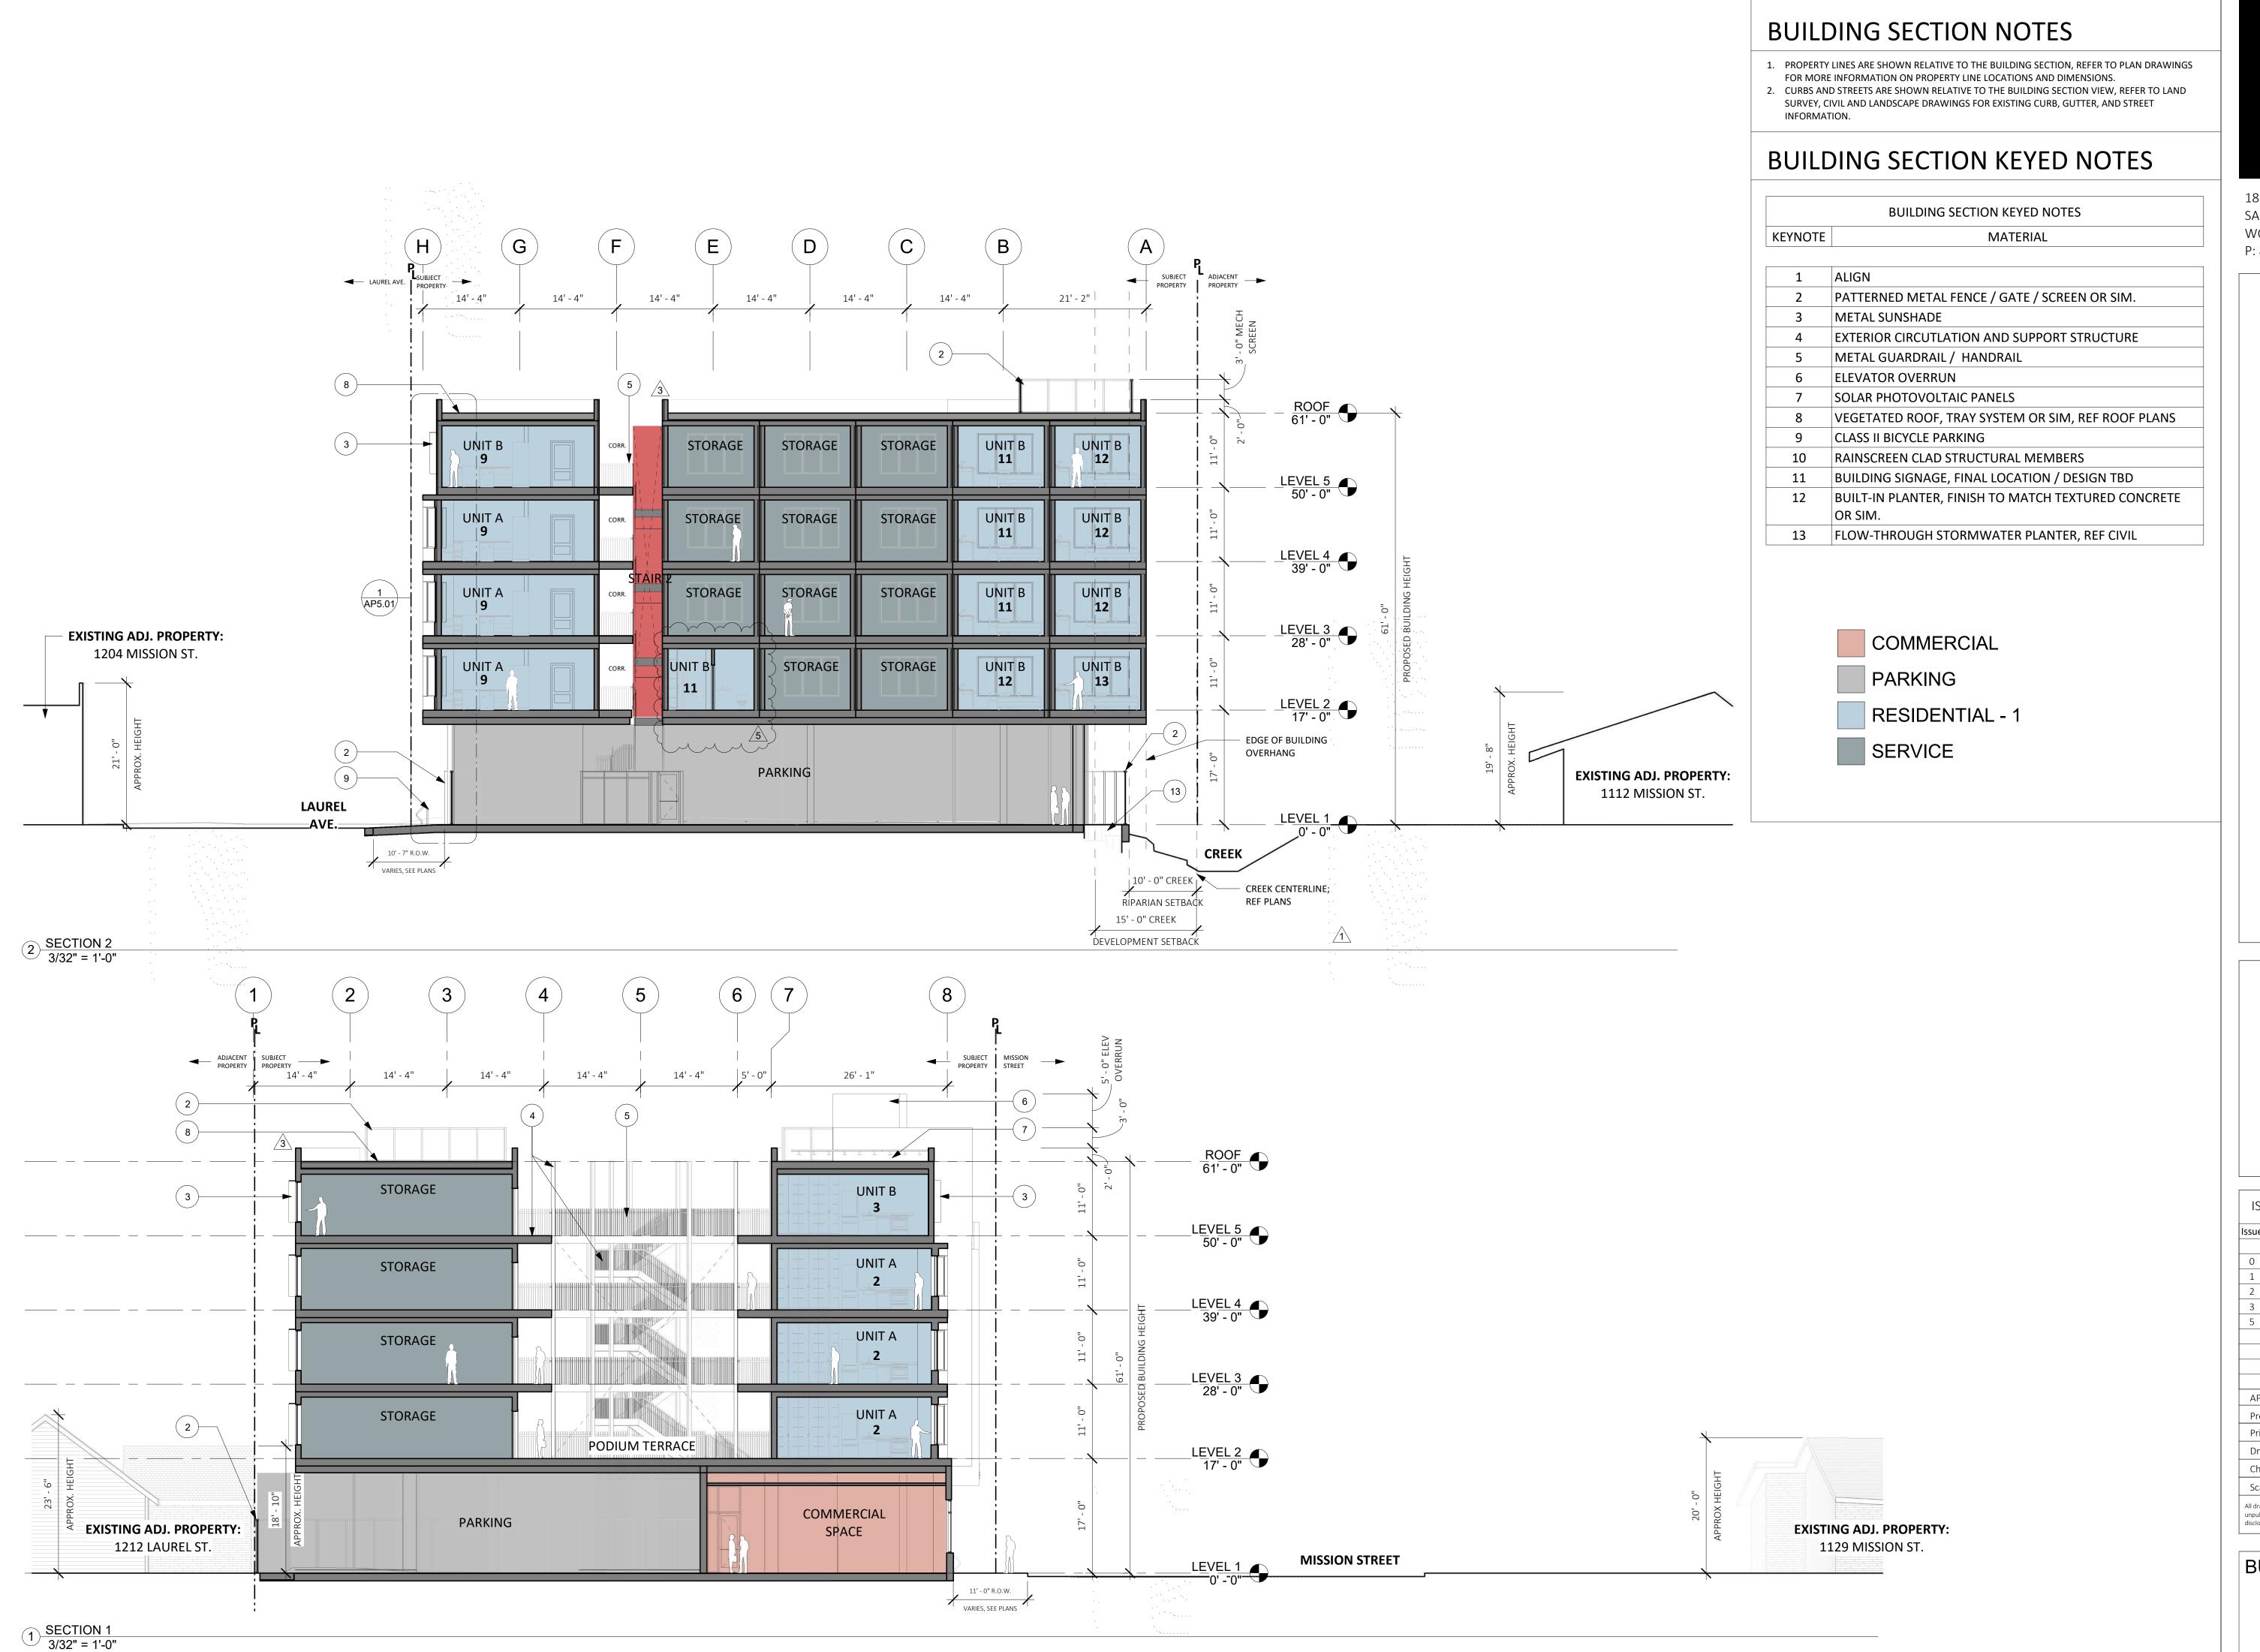



189 WALNUT AVENUE SANTA CRUZ, CA 95060 WORKBENCHBUILT.COM

P: 831.227.2217

## MISSION 7 $\mathcal{C}$ $\vdash$ Ø 113

MISION ST. , CA 95060

. 1132 CRUZ,

1130 SANT

ISS	SUES/ REVISIONS	
Issue	DESCRIPTION	DATE
	SB330 PRE-APPLICATION	01.09.2023
0	PLANNING APPLICATION	06.01.2023
1	PLANNING REV-01	08.25.2023
2	PLANNING REV-02	01.04.2024
3	PLANNING REV-03	03.11.2024
5	PLANNING REV-05	04.24.2024
APN	I number 0	06-203-25
Proj	ject number	21128
Prin	t Date (	1.09.2023
Dra	wn by	MB
Che	cked by	EB
Scal	le As	indicated
unpubli	vings and written material appearing herin c shed work of Workbench, Inc. and may not sd without written consent of the Workbenc	be duplicated, used or


**BUILDING SECTIONS** 


AP4.01

#### **BUILDING SECTION NOTES**

- 1. PROPERTY LINES ARE SHOWN RELATIVE TO THE BUILDING SECTION, REFER TO PLAN DRAWINGS FOR MORE INFORMATION ON PROPERTY LINE LOCATIONS AND DIMENSIONS.
- 2. CURBS AND STREETS ARE SHOWN RELATIVE TO THE BUILDING SECTION VIEW, REFER TO LAND SURVEY, CIVIL AND LANDSCAPE DRAWINGS FOR EXISTING CURB, GUTTER, AND STREET INFORMATION.

#### **BUILDING SECTION KEYED NOTES**

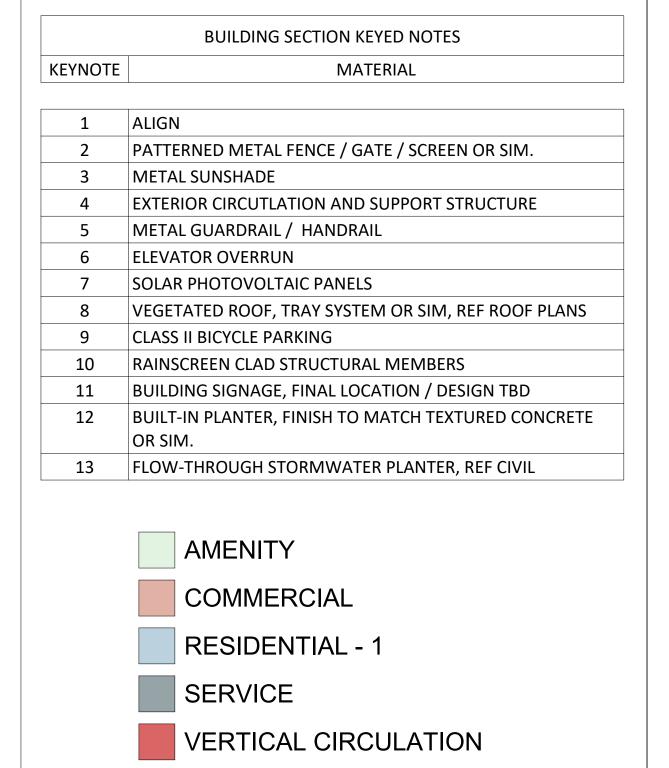

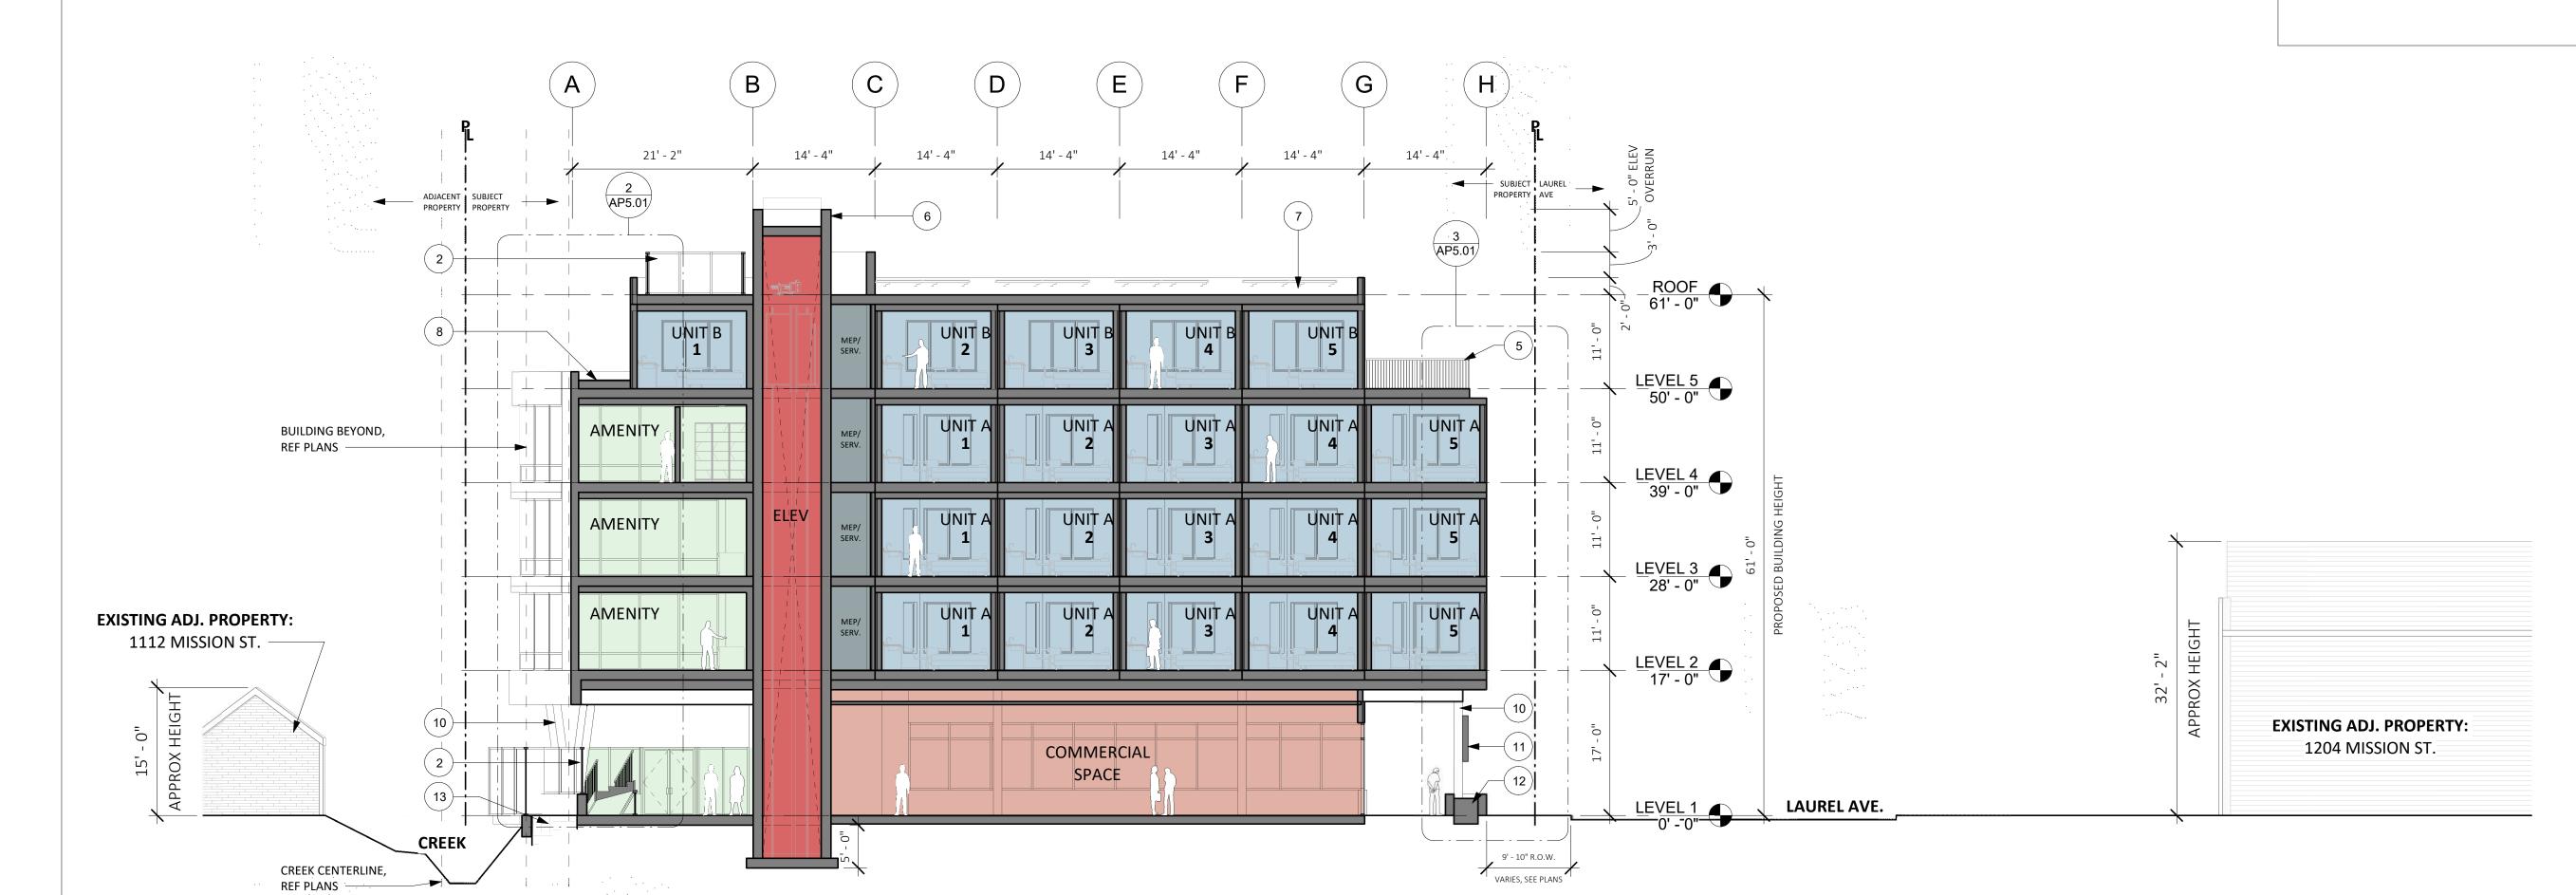

R PARIAN SETBACK

1 SECTION 3 3/32" = 1'-0"

15' - 0" CREEK

DEVELOPMENT SETBACK



189 WALNUT AVENUE SANTA CRUZ, CA 95060 WORKBENCHBUILT.COM

P: 831.227.2217

## MISSION 32 $\infty$ 11

MISION ST. , CA 95060

1130 SANT

ISS	SUES/ REVISIONS	
ssue	DESCRIPTION	DATE
0	PLANNING APPLICATION	06.01.2023
1	PLANNING REV-01	08.25.2023
2	PLANNING REV-02	01.04.2024
3	PLANNING REV-03	03.11.2024
APN	I number 006	5-203-25
Proj	ect number	21128
Prin	t Date 01.	.09.2023
Dra	wn by	ОН
Che	cked by	EB
Scal	e As ir	ndicated
unpubli	rings and written material appearing herin consti shed work of Workbench, Inc. and may not be di d without written consent of the Workbench, In	uplicated, used or

BUILDING SECTIONS

AP4.02

### 14 ROOF TERRACE LEVEL 5 50' - 0" LEVEL 5 50' - 0" LEVEL 5 50' - 0" <u>UNIT</u>A LEVEL 4 39' - 0" LEVEL 4 39' - 0" LEVEL 4 39' - 0" UNIT A AMENITY LEVEL 3 28' - 0" LEVEL 3 28' - 0" LEVEL 3 28' - 0" 11)— UNIT A AMENITY 7 6 LEVEL 2 17' - 0" LEVEL 2 17' - 0" LEVEL 2 17' - 0" 5 PARKING EXTERIOR LOBBY 10 2 LEVEL 1 0' - 0" LEVEL 1 0' - 0" LEVEL 1 0' - 0" 1 SOUTH FACADE WALL SECTION-A 1/4" = 1'-0" 2 NORTH FACADE WALL SECTION 1/4" = 1'-0" 3 SOUTH FACADE WALL SECTION-B 1/4" = 1'-0"

#### WALL SECTION GENERAL NOTES

- 1. PROPERTY LINES ARE SHOWN RELATIVE TO THE WALL SECTION, REFER TO PLAN DRAWINGS FOR MORE INFORMATION ON PROPERTY LINE LOCATIONS AND DIMENSIONS.
- CURBS AND STREETS ARE SHOWN RELATIVE TO THE WALL SECTION VIEW, REFER TO LAND SURVEY, CIVIL AND LANDSCAPE DRAWINGS FOR EXISTING CURB, GUTTER, AND STREET INFORMATION.

#### WALL SECTION KEYED NOTES

	WALL SECTION KEYED NOTES
KEYNOTE	MATERIAL
1	ALIGN
2	TEXTURED CONCRETE, BOARD FORMED OR SIM.
3	PATTERNED METAL FENCE / GATE / SCREEN OR SIM.
4	RAINSCREEN CLAD STRUCTURAL MEMBERS
5	WARM BRONZE TONED METAL PANEL OR SIM.
6	WARM BRONZE TONED METAL PANEL OR SIM.
7	GLAZED ALUMINUM WINDOW SYSTEM OR SIM.
8	VEGETATED ROOF, TRAY SYSTEM
	OR SIM.
9	TEXTURED FIBER CEMENT PANE OR SIM.
10	CLASS II BICYCLE PARKING
11	WHITE FIBER CEMENT PANEL OR STUCCO OR SIM.
12	ALUMINUM OR VINYL WINDOW
13	METAL SUNSHADE
14	GREY FIBER CEMENT PANEL OR STUCCO OR SIM.
15	BUILT-IN PLANTER, FINISH TO MATCH TEXTURED CONCRETE OR SIM.
16	BUILDING SIGNAGE, FINAL LOCATION / DESIGN TBD
17	METAL GUARDRAIL OR HANDRAIL
18	PLANTER / PLANTER BENCH
19	PARAPET



189 WALNUT AVENUE SANTA CRUZ, CA 95060 WORKBENCHBUILT.COM

P: 831.227.2217

## MISSION 32 $\vdash$ $\infty$ 1130

MISION ST. ., CA 95060

1130 SANT



Issue	DESCRIPTIC	N	DATE
0	PLANNING APPLI	CATION 0	6.01.20
1	PLANNING RE	V-01 0	8.25.20
2	PLANNING RE	V-02 0	1.04.20
3	PLANNING RE	V-03 0	3.11.20
APN	l number	006-2	203-2
Pro	ject number		2112
Prir	nt Date	01.0	9.202
Dra	wn by		M
Che	ecked by		E
Sca	le	1/4"	= 1'-0

ENLARGED WALL SECTIONS

AP5.01








DOUBLE STORAGE LOCKER

PROPOSED SIGN PLAN
1/4" = 1'-0"



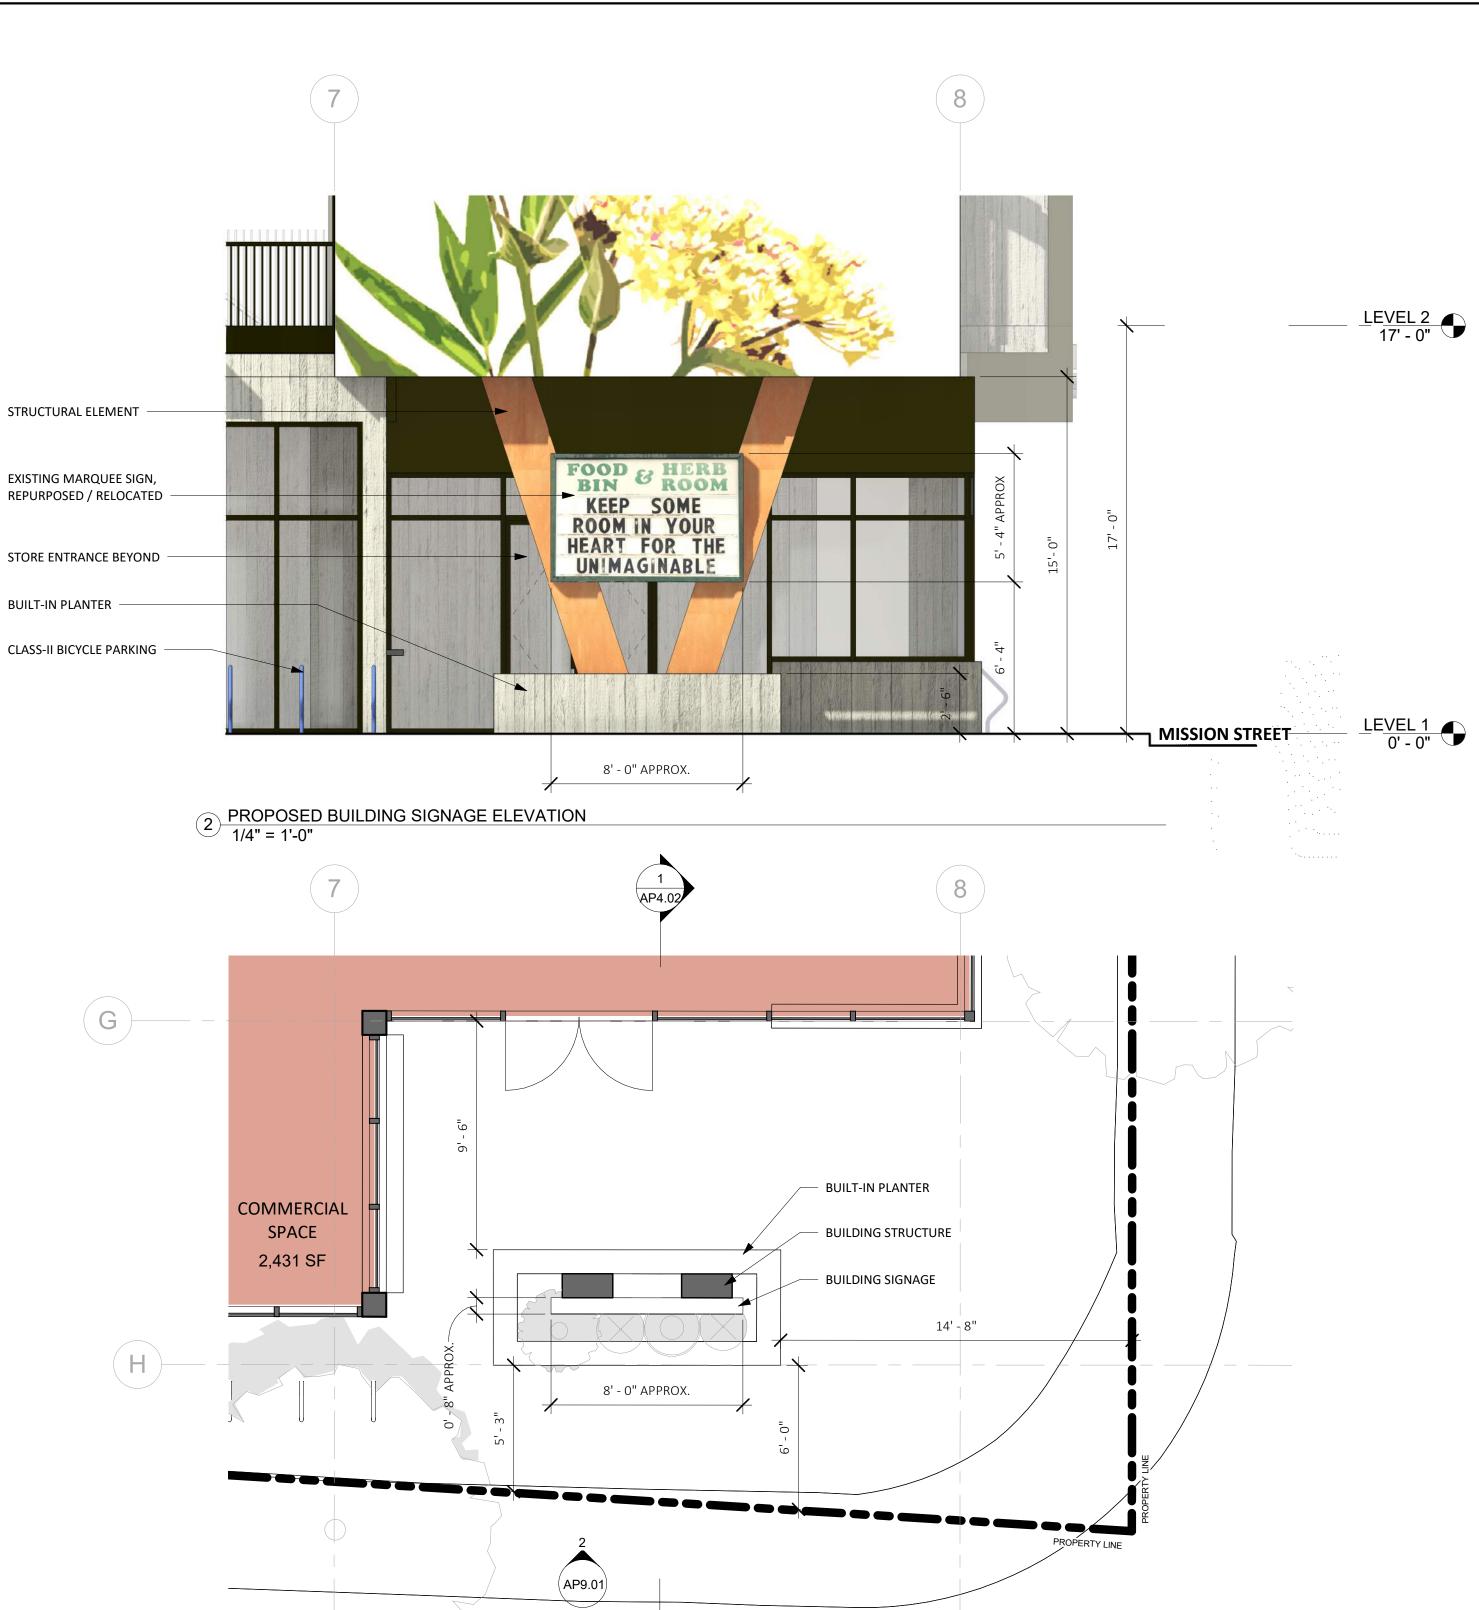

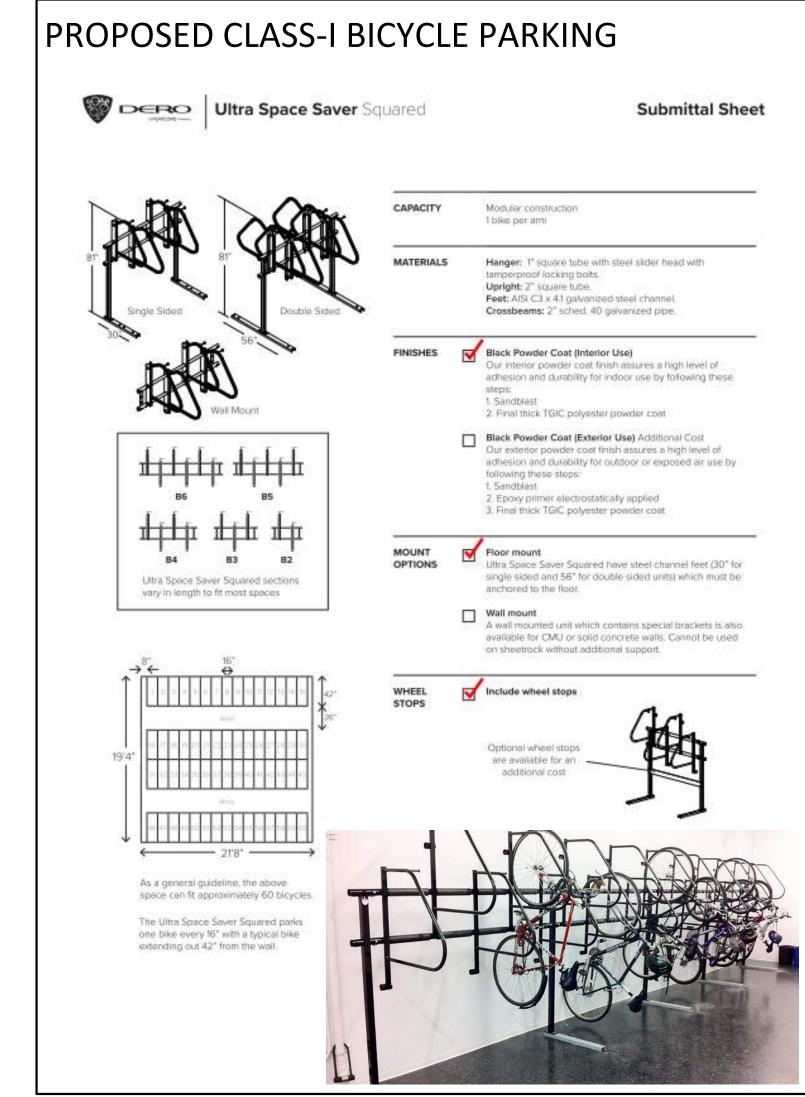

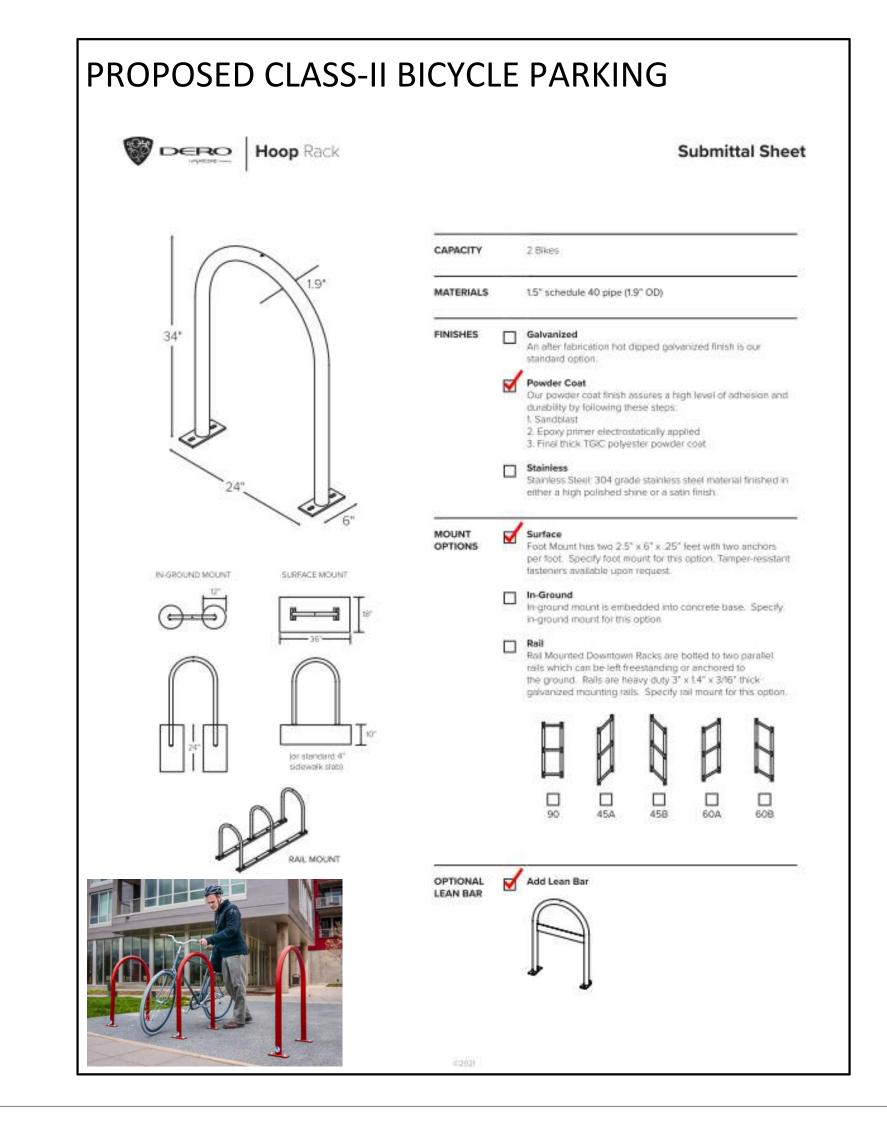



189 WALNUT AVENUE SANTA CRUZ, CA 95060 WORKBENCHBUILT.COM

P: 831.227.2217

### MISSION 7 $\mathcal{C}$ $\vdash$ $\Box$ $\infty$

 $\vdash$ 

MISION ST. , CA 95060

7

1130 SANT



Issue	DESCRIPTION	DATE
	SB330 PRE-APPLICATION	01.09.202
0	PLANNING APPLICATION	06.01.202
1	PLANNING REV-01	08.25.202
2	PLANNING REV-02	01.04.202
3	PLANNING REV-03	03.11.202
APN	I number 00	6-203-25
Pro	ect number	21128
Prin	t Date 01	1.09.2023
Dra	wn by	OH
Che	cked by	EB
Scal	e	NTS

CAR, EV, BICYCLE PARKING, & STORAGE INFO AP9.01